



Development Review Committee

1020 East Pioneer Road
Draper, UT 84020

STAFF REPORT

February 5, 2021

To: Jennifer Jastremsky, Zoning Administrator

Approved Date

From: Travis Van Ekelburg, Planner II
801-576-6522, travis.vanekelburg@draperutah.gov

Re: T-Mobile Antenna-Permitted Use Permit Request

Application No.: USE-1118-2020
Applicant: Declan Murphy, representing T-Mobile Wireless
Project Location: Approximately 250 W 12300 S
Current Zoning: CBP (Business/Manufacturing Park) Zone
Acreage: Approximately 6.49 Acres (Approximately 282,704 ft²)
Request: Request for approval of a Permitted Use Permit in the CBP zone regarding an existing wireless facility equipment upgrade for the existing SL03000A Wireless Facility.

SUMMARY AND BACKGROUND

The subject property is part of the Lone Peak Business Park that was created in the year 2000 and amended in 2009. This application is a request for approval of a Permitted Use Permit for approximately 6.49 acres located on the north side of 12300 S, at approximately 250 W 12300 S (Exhibit B). Specifically the applicant is requesting that a Permitted Use Permit be approved to allow for an equipment upgrade on an existing rooftop Wireless Facility. The property is currently zoned CBP. The property is owned by Price Lone Peak West LLC; and is currently used as a warehouse.

To keep up with the changes in wireless communication technology, T-Mobile is upgrading many of its facilities throughout the valley. The current application pertains to the existing Wireless Facility known as SL03000A. This is a roof-top facility that is mounted to the building's roof-top HVAC equipment that is screened from view and is not visible from ground level.



ANALYSIS

General Plan and Zoning. The Land Use Map of the General Plan calls for the Commercial Special District land use designation for the subject property (Exhibit C). This category is characterized as follows:

Commercial Special District

LAND USE DESCRIPTION	
CHARACTERISTICS	<ul style="list-style-type: none"> • Include a wide range of commercial uses that are destination oriented and draw from a regional customer base • Compatible, master planned mix of day and evening uses consisting of office, light manufacturing, retail, residential, recreation and open space components • Limited traffic access points • Development is intended to consist of well designed, architecturally integrated structures which are appropriately landscaped and buffered from surrounding land uses • Uniform design standards and aesthetics • Access to individual properties should be provided only from frontage roads or major arterials • Common off-street traffic circulation and parking areas
LAND USE MIX	<ul style="list-style-type: none"> • Large-scale master-planned commercial centers • Big box centers • Corporate headquarters • Multi-story upscale office buildings • Multi-story upscale residential buildings
COMPATIBLE ZONING	<ul style="list-style-type: none"> • Adopted Commercial Special District zone • Adopted Major Freeway Arterial Frontage Road zone
LOCATION	<ul style="list-style-type: none"> • Strategically placed along high-traffic corridors with convenient points of traffic access to and from residential areas • Excellent transportation access to major highways • High visibility from the I-15 corridor • Proximity to both Salt Lake and Utah Counties • Provide adequate buffers in the form of setbacks, open space, low impact industrial uses, barriers, etc. adjacent to existing residential areas • Major streets serving these areas should accommodate truck traffic

The property has been assigned the CBP zoning classification (Exhibit D). According to Draper City Municipal Code (DCMC) Section 9-8-020 the purpose of the CBP zone is *“to provide aesthetically attractive planned developments having a mix of office, research and development, light manufacturing, and limited retail uses. Typical uses in this zone include offices, clean indoor manufacturing facilities, service retail, restaurants, athletic clubs, personal service shops, medical offices, office/warehouse buildings, and research facilities.”* The CBP zoning surrounds the subject property.



Requested Modification. This request is an equipment upgrade and there will be no change to the facility's approved use as a wireless facility. This facility is on the roof portion of the building and will be an upgrade for better wireless and data coverage. The proposed antennas will mount in the same location for the three antenna sectors that are required for cellular communication. Each of the three sectors will have three antennas as a total configuration. The original height the antennas are set at is 7-feet. The height of the new antennas will still meet ordinance maximums at 10-feet in total height. A new mount will be required to hold the additional two antennas to include the existing antenna that will not be removed for the final antenna configuration of three per sector. The additional equipment change proposed will not be a noticeable difference after installation as the components are similar in size and function as the components they are replacing. The proposal consists of the following changes:

- Remove existing AC breaker
- Remove 3 antennas, 1 per sector
- Remove 6 radio modules, 2 per sector
- Relocate 1 antenna
- Relocate 2 radio modules
- Add new AC breaker
- Add 2 inch conduit for power line
- Add 2 new equipment cabinets
- Add 3 hybrid cables
- Add mounts for structural
- Add 6 antennas, 2 per sector
- Add 6 radio modules, 2 per sector

Criteria For Approval. The criteria for review and potential approval of a Permitted Use Permit request is found in Sections 9-5-070(E) of the Draper City Municipal Code. This section depicts the standard of review for such requests as:

Criteria For Approval. The criteria for review and potential approval of a Permitted Use Permit request is found in Sections 9-5-070(E) of the DCMC. This section depicts the standard of review for such requests as:

- E. Approval Standards: The following standards shall apply to the issuance of a permitted use permit. A permitted use shall:
1. Be allowed as a permitted use in the applicable zone;
 2. Conform to development standards of the applicable zone;
 3. Conform to applicable regulations of general applicability and regulations for specific uses set forth in this title;
 4. Not be located on any land classified as a primary or secondary conservation area or sensitive land area, except as expressly permitted by provisions of this title;
 5. Not be located in any protected area as shown on a natural resource inventory; and
 6. Conform to any other applicable requirements of this code.

The criteria for review and potential approval of a Wireless Telecommunications Facilities request is found in Sections 9-41-050(I) of the DCMC. This section depicts the standard of review for such requests as:

DCMC Section 9-41-050 (I): I. Facilities Located In Commercial Zones: The facilities set forth below shall be permitted uses in commercial and industrial zones so long as they



meet the requirements of this subsection and are not located on otherwise vacant property:

1. Hidden antennas.
2. Stealth design antennas.
3. Flush mounted wall antennas.
4. Roof mounted antennas that are:
 - a. Completely enclosed from view within an architecturally compatible screen approved by staff.
 - b. Set back at least ten feet (10') from exterior walls of the building on nonparapet wall buildings, or ten feet (10') from the parapet wall on parapet wall buildings.

REVIEWS

Planning Division Review. The Draper City Planning Division has completed their review of the Permitted Use Permit submission. Comments from this division, if any, can be found in Exhibit A.

Engineering and Public Works Divisions Review. The Draper City Engineering and Public Works Divisions have completed their reviews of the Permitted Use Permit submission. Comments from these divisions, if any, can be found in Exhibit A.

Fire Division Review. The Draper City Fire Marshal has completed his review of the Permitted Use Permit submission. Comments from this division, if any, can be found in Exhibit A.

STAFF RECOMMENDATION

Staff finds that the application complies with the DCMC and recommends that the Zoning Administrator review the request and approve the application based on the findings listed below and the criteria for approval, as listed within the staff report.

Conditions of approval:

1. The applicant shall obtain all applicable permits from Draper City, Fire Division and the Building Division for this upgrade.
2. Per DCMC Section 9-5-070(J) A Permitted Use shall expire if not exercised within one hundred eighty (180) days of issuance.

The findings for approval as are follows:

2. That the proposed changes will have no perceptible visual impact.
3. That the proposed changes are compliant with Section 9-5-070(E) of the DCMC.
4. That the proposed changes are compliant with Section 9-41-050(I) of the DCMC.



DEVELOPMENT REVIEW COMMITTEE ACKNOWLEDGEMENT

We, the undersigned, as duly appointed members of the Draper City Development Review Committee, do acknowledge that the application which provides the subject for this staff report has been reviewed by the Committee and has been found to be appropriate for review by the Draper City Planning Commission and/or City Council.

Brien Maxfield

Digitally signed by Brien Maxfield
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email=brien.maxfield@draper.ut.us, c=US
Date: 2021.02.10 16:53:34 -0700

Draper City Public Works Department

Jennifer Jastremsky

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O=Draper City Planning, CN=Jennifer Jastremsky
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Draper City Planning Division

Don Buckley

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O=Draper City Fire Department, OU=Fire
Marshal, CN=Don Buckley
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Draper City Fire Department

Mike Barker

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c=US
Date: 2021.02.11 09:02:25 -0700

Draper City Legal Counsel

Matthew T. Symes

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O=Draper City, CN=Matthew T. Symes
Date: 2021.02.11 05:05:42-0700

Draper City Building Division

EXHIBIT A
DEPARTMENT REVIEWS

REVIEWS ARE NOT MEANT TO BE AN ALL INCLUSIVE LIST OF POSSIBLE COMMENTS OR CONDITIONS.

Planning Division Review.

1. No comments.

Engineering and Public Works Divisions Review.

1. No comments.

Fire Division Review.

1. 2A-10BC Fire Extinguishers required. The extinguisher needs to be a serviceable type meaning metal head and metal neck. Extinguishers need to be located in a conspicuous location where they will be readily accessible and immediately available for use. Placed on every level of the home. If in cabinet or not the extinguisher or cabinet needs to be mounted so that the top is not more than five (5) feet above the floor.
2. Fire Department Access is required to be maintained. Vehicles cannot park in such a way to impede fire department or emergency vehicle access.
3. Hazardous Material Permit – A Draper City Fire Hazardous Material Permit may need to be obtained. This is for all new and existing installations.

Notes:

Plan approval or review shall not be construed to relieve from or lessen the responsibility of any person designing, owning, operating or controlling any building. Damages to persons or property caused by defects, fire, improper installation, or other emergency conditions that occur in or on the building property shall not hold the Draper City Fire Department as assuming any liability.

EXHIBIT B AERIAL MAP



T-Mobile Antenna
Aerial Map

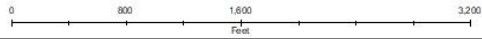


EXHIBIT C LAND USE MAP

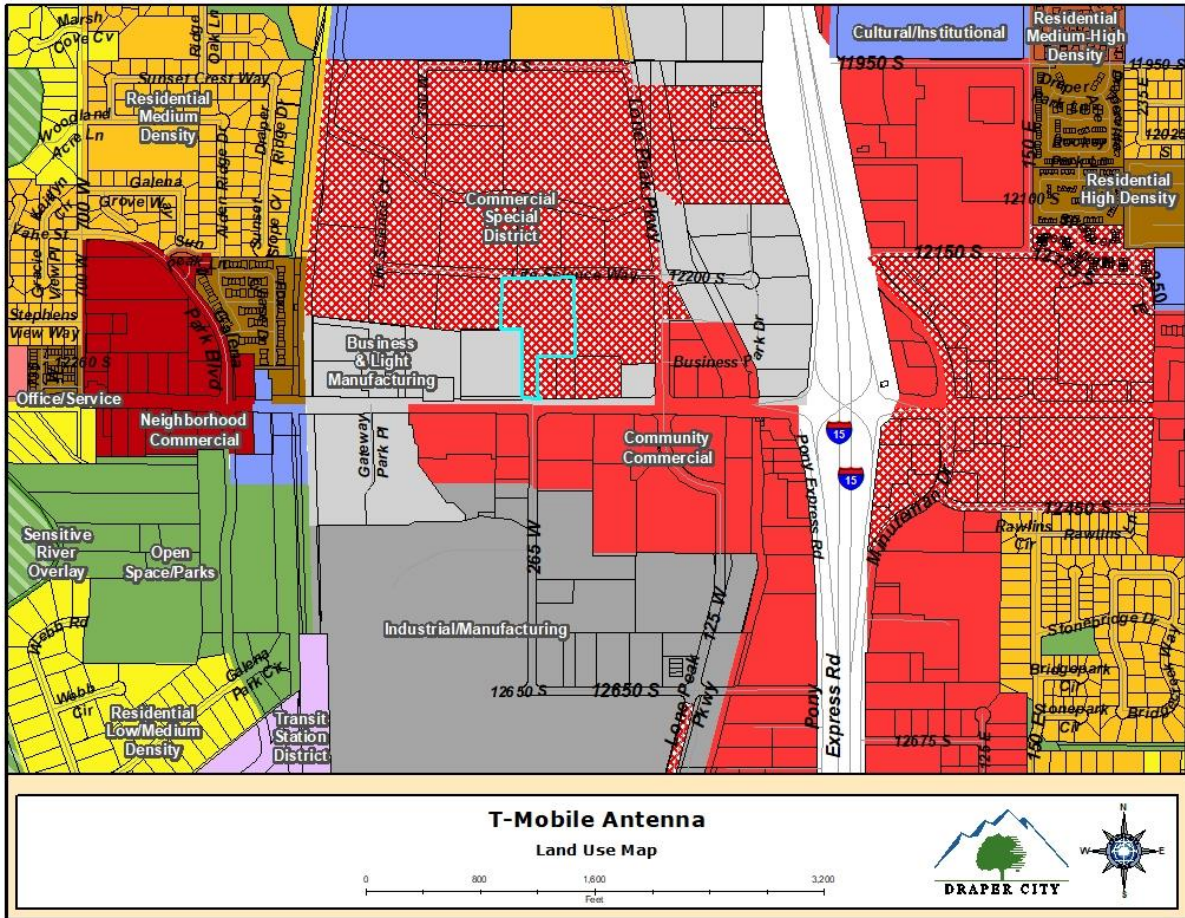
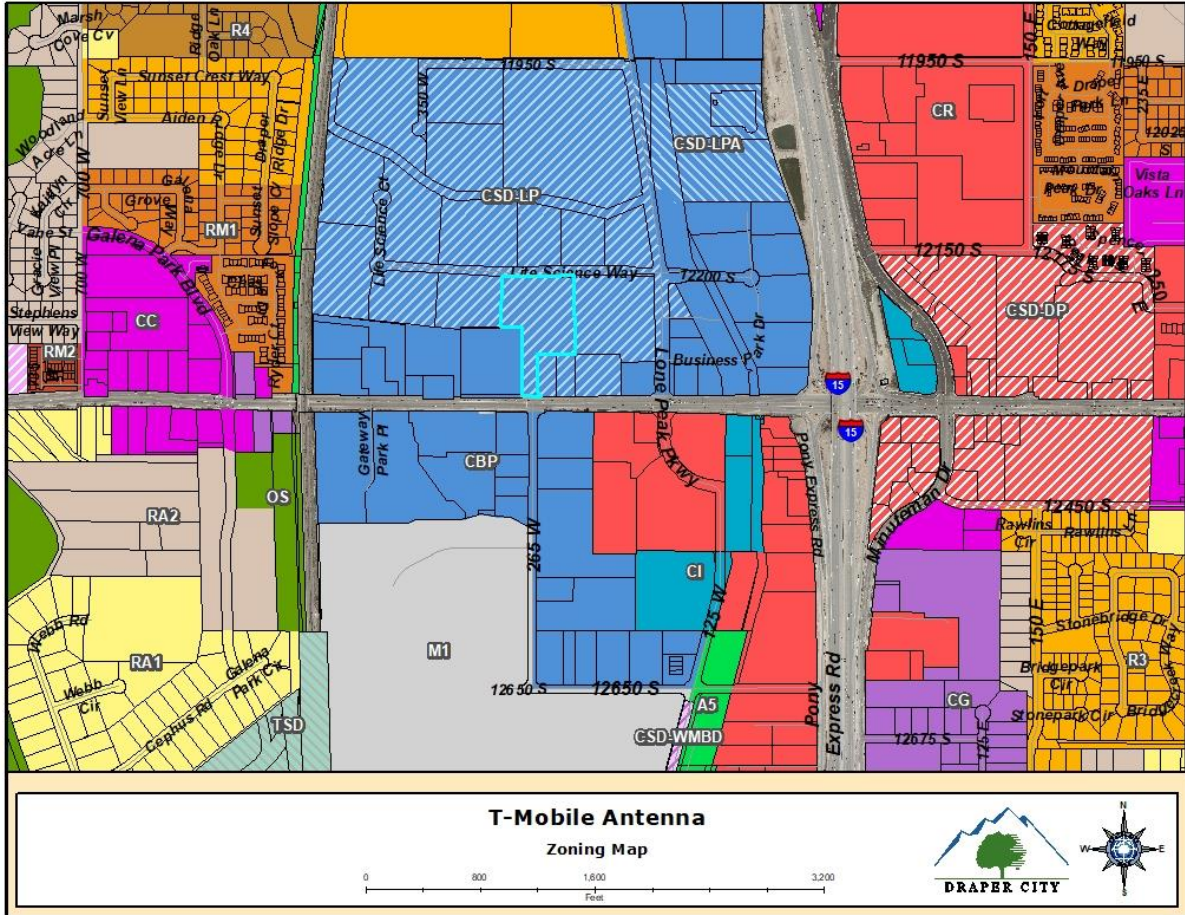


EXHIBIT D ZONING MAP




**EXHIBIT E
DRAWINGS**

T-Mobile

SITE #: SL03000A
SITE NAME: DRAPER SWITCH
STATE: UTAH
COUNTY: SALT LAKE COUNTY
DESIGN TYPE: ANCHOR

CLIENT
T-Mobile
 121 ELECTION RD.
 DRAPER, UTAH 84020

CONSULTANT
COAL CREEK CONSULTING
 2166 E. UNIVERSITY DR., STE 201
 TEMPE, ARIZONA 85281
 PHONE: (602) 429-0533 FAX: (480) 638-2852

ENGINEER OF RECORD
TERRA DYNAMIC ENGINEERING, LLC

 P.O. BOX 22131, PHOENIX, AZ 85028
 PHONE: (602) 482-1603
 EMAIL: ROBERT@TERRADYNAMIC.US

SEAL

CODE COMPLIANCE:

ALL WORK AND MATERIALS SHALL BE PERFORMED AND INSTALLED IN ACCORDANCE WITH THE CURRENT EDITIONS OF THE FOLLOWING CODES ADOPTED BY THE LOCAL GOVERNING AUTHORITIES. NOTHING IN THESE PLANS IS TO BE CONSTRUCTED TO PERMIT WORK NOT CONFORMING TO THESE CODES.

- 2018 INTERNATIONAL BUILDING CODE
- 2018 INTERNATIONAL MECHANICAL CODE
- 2017 NATIONAL ELECTRICAL CODE/NFPA-70

ACCESSIBILITY REQUIREMENTS:

THIS FACILITY IS UNMANNED AND NOT FOR HUMAN HABITATION. HANDICAPPED ACCESS REQUIREMENTS ARE NOT REQUIRED IN ACCORDANCE WITH THE CURRENT INTERNATIONAL BUILDING CODE.

ENGINEERS NOTES:

- IF A DISCREPANCY ARISES BETWEEN THE DRAWINGS AND FIELD CONDITIONS, OR WHERE A DETAIL IS DOUBTFUL OF INTERPRETATION, OR AN UNANTICIPATED FIELD CONDITION IS ENCOUNTERED, THE ENGINEER SHALL BE CALLED IMMEDIATELY FOR PROCEDURE TO BE FOLLOWED. SUCH INSTRUCTIONS SHALL BE CONFIRMED IN WRITING AND DISTRIBUTED TO ALL AFFECTED PARTIES.
- THE ENGINEER WILL NOT BE RESPONSIBLE FOR CONSTRUCTION MEANS, METHODS, TECHNIQUES, SEQUENCES, PROCEDURES, SAFETY PRECAUTIONS, OR PROGRAMS UTILIZED IN CONNECTION WITH THE WORK, AND WILL NOT BE RESPONSIBLE FOR THE CONTRACTOR'S FAILURE TO CARRY OUT THE WORK IN ACCORDANCE WITH THE CONSTRUCTION DRAWING AND/OR DOCUMENTS.
- CONTRACTOR SHALL BE RESPONSIBLE FOR PROPER LAYOUT OF IMPROVEMENTS BASED UPON SETBACKS/ PROPERTY LINE LOCATION. DIMENSIONAL RELATIONSHIPS TO EQUIPMENT ARE APPROXIMATE AND ARE FOR ILLUSTRATIVE PURPOSES ONLY.
- CONTRACTOR TO MAINTAIN ALL DRAINAGE PATHS FREE FROM ANY OBSTRUCTIONS (I.E. DEBRIS AND SILT).
- CONTRACTOR TO PROVIDE POSITIVE DRAINAGE AWAY FROM EQUIPMENT.
- IF THE SPECIFIED EQUIPMENT CANNOT BE INSTALLED AS SHOWN ON THESE DRAWINGS, THE SUBCONTRACTOR SHALL PROPOSE AN ALTERNATIVE INSTALLATION FOR APPROVAL BY THE CONTRACTOR AND ENGINEER OF RECORD.
- SUBCONTRACTOR SHALL DETERMINE ACTUAL ROUTING OF CONDUIT, POWER AND TI CABLES, GROUNDING CABLES AS SHOWN ON THE POWER, GROUNDING AND TELCO PLAN DRAWING. SUBCONTRACTOR SHALL UTILIZE EXISTING TRAYS AND/OR SHALL ADD NEW TRAYS AS NECESSARY. SUBCONTRACTOR SHALL CONFIRM THE ACTUAL ROUTING WITH THE CONTRACTOR. ROUTING OF TRENCHING SHALL BE APPROVED BY CONTRACTOR

UTILITY NOTES:

- IT SHALL BE THE CONTRACTORS RESPONSIBILITY TO CONTACT BLUESTAKE AT LEAST TWO FULL WORKING DAYS (48 HOURS) PRIOR TO BEGINNING OF ANY EXCAVATING.
- IT SHALL BE THE CONTRACTORS RESPONSIBILITY TO LOCATE ALL STRUCTURES, UNDERGROUND PIPELINES, ELECTRIC AND TELEPHONE CONDUITS, EITHER SHOWN OR NOT SHOWN ON THE PLANS PRIOR TO ANY CONSTRUCTION, AND TO OBSERVE ALL POSSIBLE PRECAUTIONS TO AVOID ANY DAMAGE TO THESE FACILITIES. THE ENGINEERING AND/OR DEVELOPER WILL NOT GUARANTEE ANY ELEVATIONS OR LOCATIONS OF EXISTING UNDERGROUND UTILITIES SHOWN ON THESE PLANS.
- CONTRACTOR TO VERIFY LOCATION AND ELEVATION OF ALL UTILITY CONNECTIONS.

PROJECT SUMMARY

SITE ADDRESS:
 268 W 12300 S
 DRAPER, UTAH 84020

PROPERTY OWNER:
 PRICE LONE PEAK WEST LLC
 250 W 12300 S
 DRAPER, UT 84020

PARCEL ID: 27254010150000
ZONING CLASSIFICATION: CBP
JURISDICTION: DRAPER CITY
LAT: 40.5287570
LONG: -111.89937500

PROJECT DESCRIPTION

T-MOBILE PROPOSES TO:

- REMOVE EXISTING AC BREAKER IN EXISTING PPC
- REMOVE (3) ANTENNAS, (1) PER SECTOR
- REMOVE (6) RADIO MODULES (2) PER SECTOR
- RELOCATE (1) ANTENNA
- RELOCATE (2) RADIO MODULES
- ADD A NEW AC BREAKER IN PPC
- ADD A 2" CONDUIT FOR POWER ROUTED TO SSC
- ADD (2) NEW EQUIPMENT CABINETS
- ADD (3) HYBRID CABLES
- ADD MOUNTS PER STRUCTURALS
- ADD (6) ANTENNAS, (2) PER SECTOR
- ADD (6) RADIO MODULES, (2) PER SECTOR

PROJECT TEAM

PROJECT MANAGER:
 T-MOBILE
 121 ELECTION RD.
 DRAPER, UTAH 84020
 CONTACT: RAQUEL ELLIS
 PHONE: (425) 279-4286
 EMAIL: RAQUEL.COLLINS26@T-MOBILE.COM

CONSTRUCTION MANAGER:
 COAL CREEK CONSULTING
 2166 E. UNIVERSITY DR., STE 201
 TEMPE, AZ 85281
 CONTACT: IAN WALKER
 PHONE (801) 946-8585

SITE ACQ. CONSULTANT:
 COAL CREEK CONSULTING
 2166 E. UNIVERSITY DR., STE 201
 TEMPE, ARIZONA 85281
 CONTACT: JACOB RYNES
 PHONE: (480) 204-8226

A&E DESIGN:
 COAL CREEK CONSULTING
 2166 E. UNIVERSITY DR., STE 201
 TEMPE, AZ 85281
 CONTACT: SHAWN EVANS
 PHONE (602) 758-5829

CIVIL ENGINEER:
 TERRA DYNAMIC ENGINEERING, LLC
 P.O. BOX 22131
 PHOENIX, ARIZONA 85028
 CONTACT: ROBERT ORLANDO
 PHONE (602) 482-1603
 EMAIL:ROBERT@TERRADYNAMIC.US

ELECTRICAL ENGINEER:
 EXCELLENCE IN ENGINEERING
 12005 ANTELOPE TRAIL
 PARKER, COLORADO 80138
 CONTACT: LOREN PRIEST
 PHONE (303) 748-1189


SHEET INDEX

T-1 TITLE SHEET, VICINITY MAP & GENERAL INFO.

CIVIL:
 C-1 SITE PLAN
 C-2 ENLARGED SITE PLAN
 C-3 EXISTING/NEW ANTENNA PLAN & EQUIPMENT PLAN
 C-4 EXISTING/NEW ELEVATION
 C-5 DETAILS

ELECTRICAL
 E-1 SPECS/GENERAL NOTES/LEGENDS/SHEET INDEX
 E-2 ENLARGED POWER PLAN
 E-3 ONE-LINE AND EXISTING/NEW PANEL SCHEDULE
 E-4 EQUIPMENT/ANTENNA GROUNDING PLAN AND NOTES

VICINITY MAP

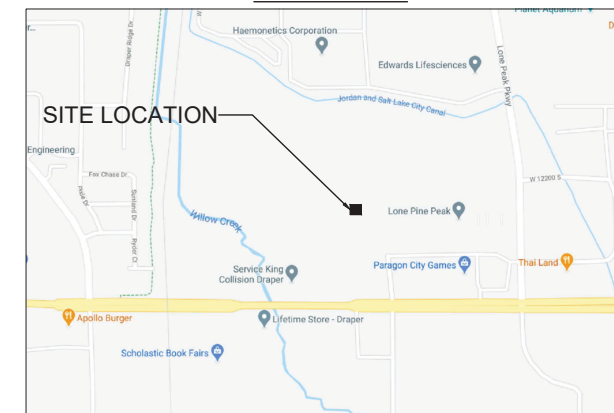

DRIVING DIRECTIONS

DIRECTIONS TO THE SITE FROM THE T-MOBILE OFFICE:
 HEAD SOUTH TOWARD LONE PEAK PKWY, TURN RIGHT, SHARP LEFT TOWARD LONE PEAK PKWY, TURN RIGHT TOWARD LONE PEAK PKWY, TURN LEFT AT THE 1ST CROSS STREET ONTO LONE PEAK PKWY, TURN RIGHT AT W 12200 S, DESTINATION WILL BE ON THE RIGHT



NO.	DATE	DESCRIPTION	BY
1	09/03/20	REVIEW	JM
2	11/13/20	REVISION 1	REW

PROJECT INFORMATION
 JOB: 13-057-04

**SL03000A
 DRAPER SWITCH**

268 W 12300 S
 DRAPER, UTAH 84020


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**TITLE SHEET, VICINITY
 MAP & GENERAL
 INFORMATION**

JURISDICTIONAL APPROVAL

SHEET NUMBER

T-1

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CLIENT
T-Mobile
 121 ELECTION RD.
 DRAPER, UTAH 84020

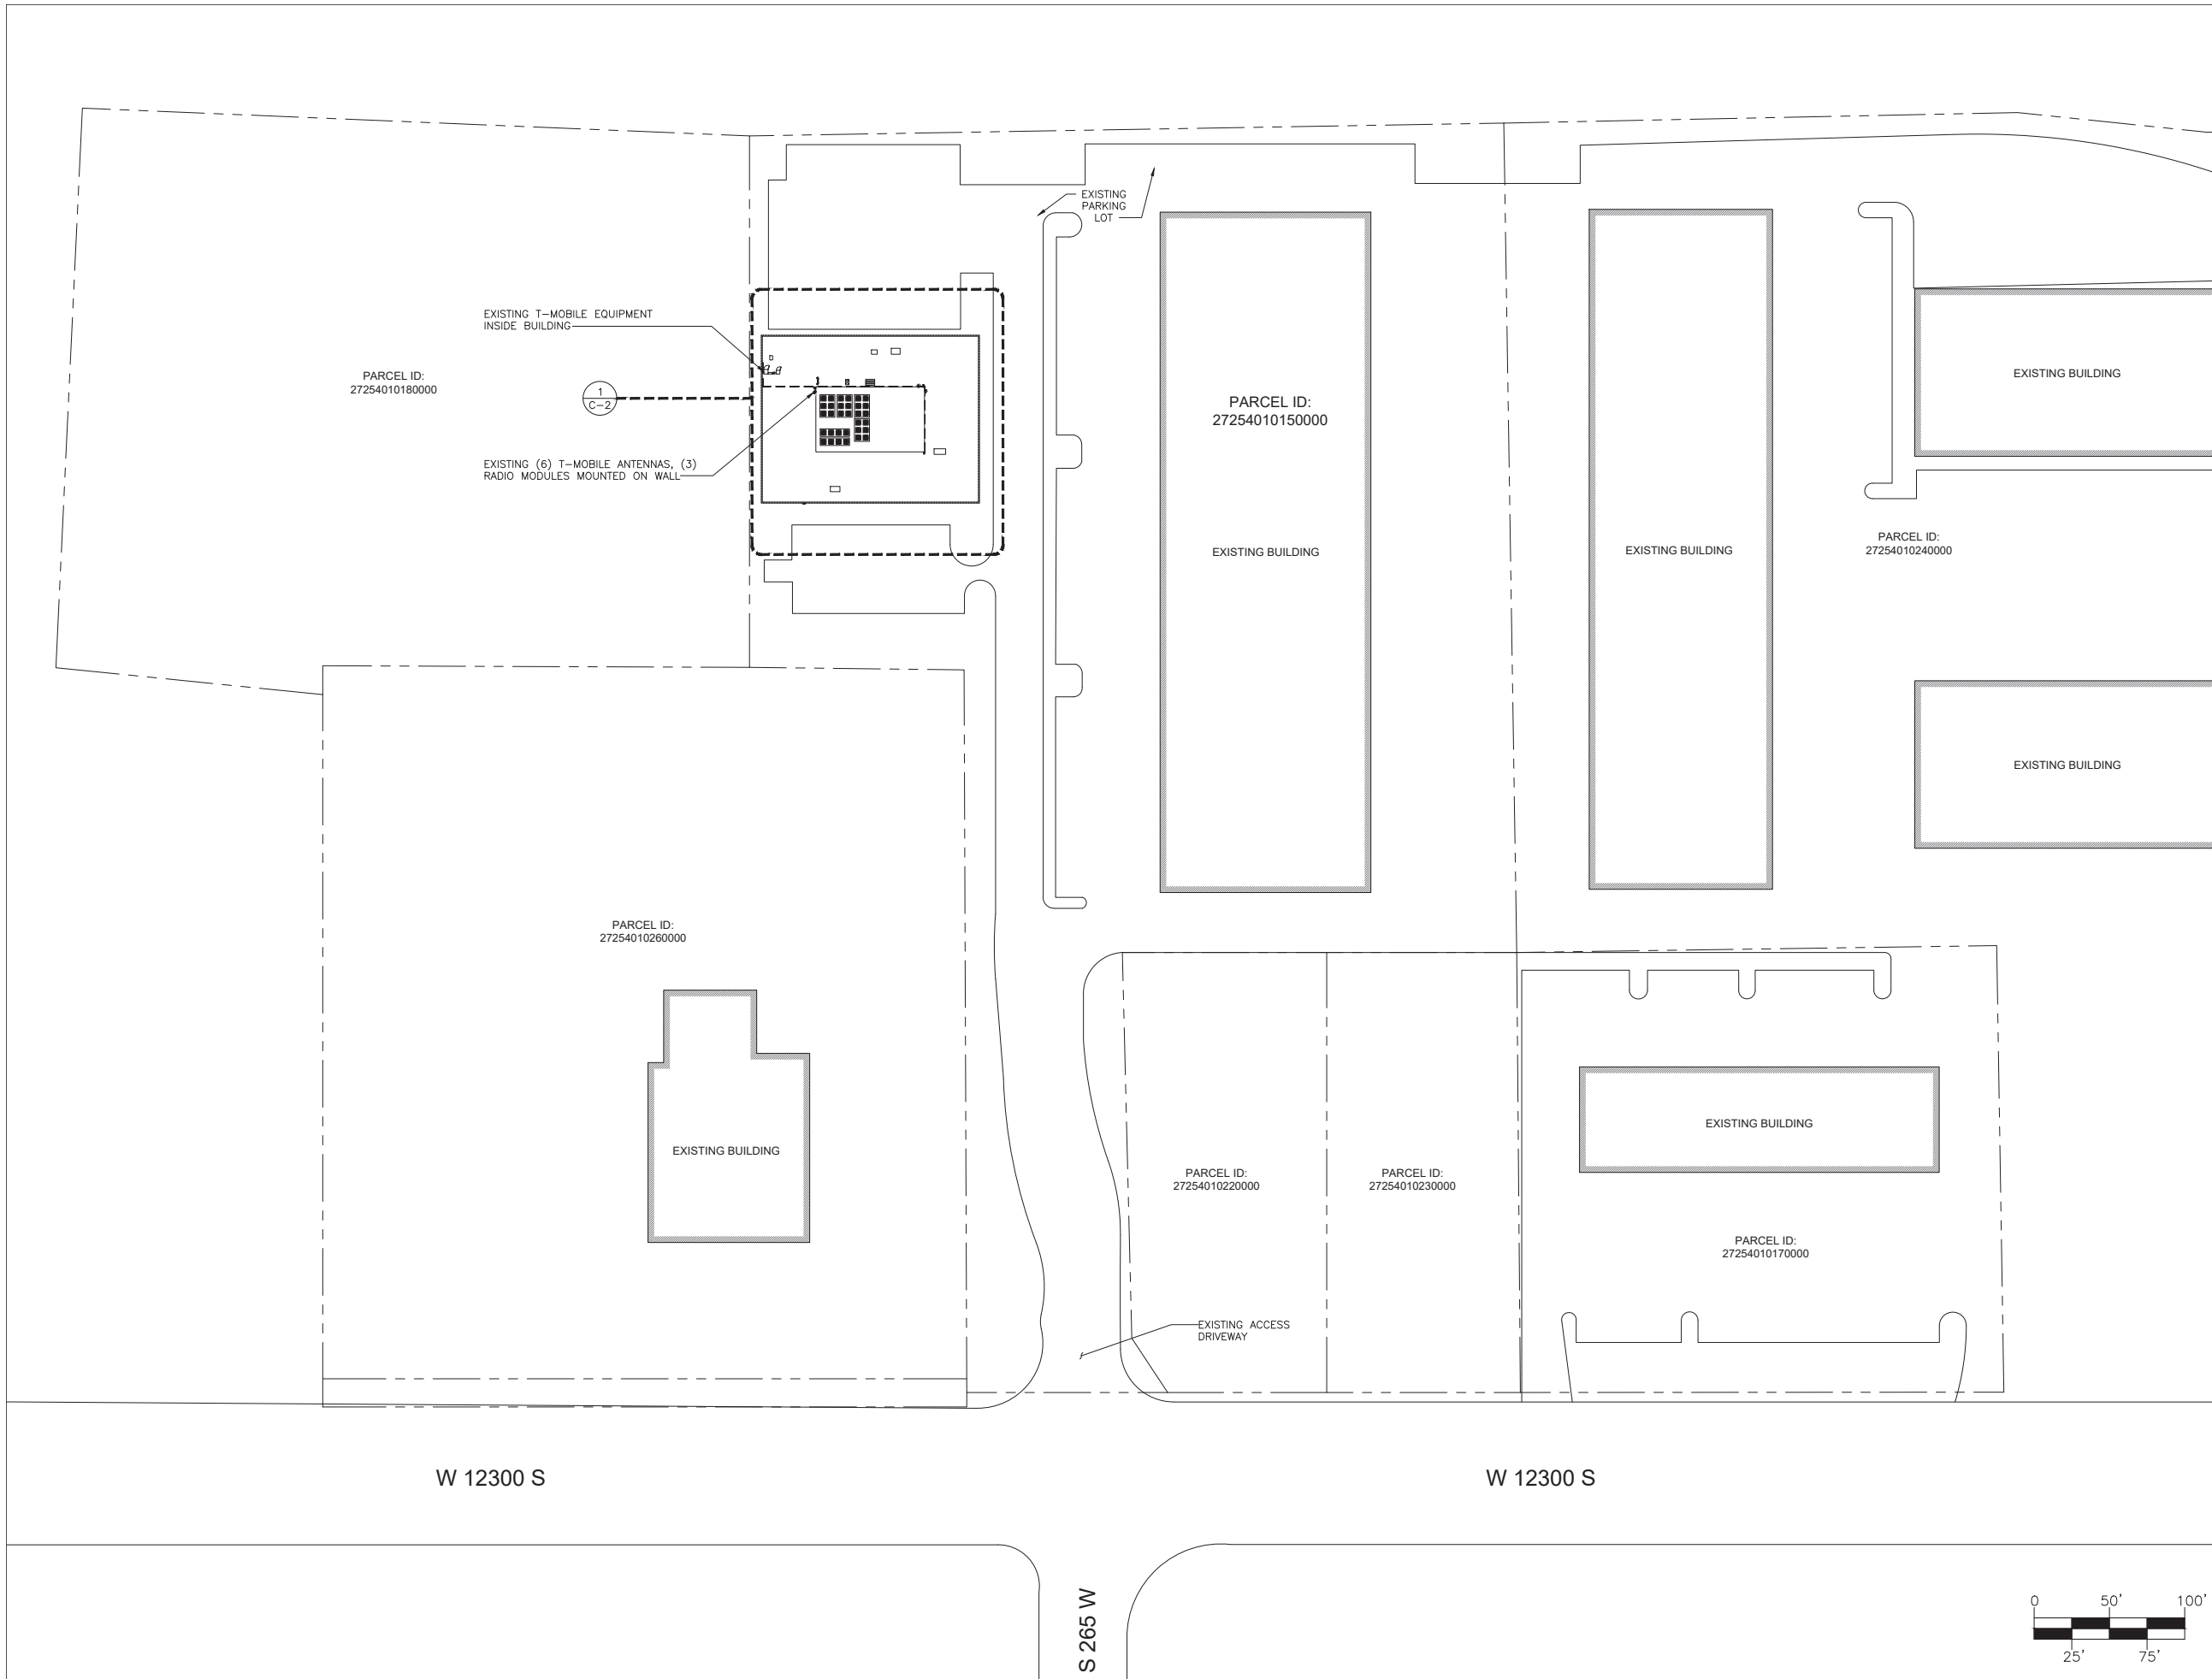CONSULTANT
COAL CREEK CONSULTING
 2166 E. UNIVERSITY DR., STE 201
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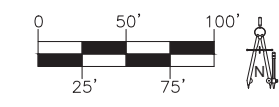
**SL03000A
 DRAPER SWITCH**

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SHEET TITLE
SITE PLAN

JURISDICTIONAL APPROVAL


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C-1



SCALE: 1" = 50'-0" 1

SITE PLAN

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**SL03000A
 DRAPER SWITCH**

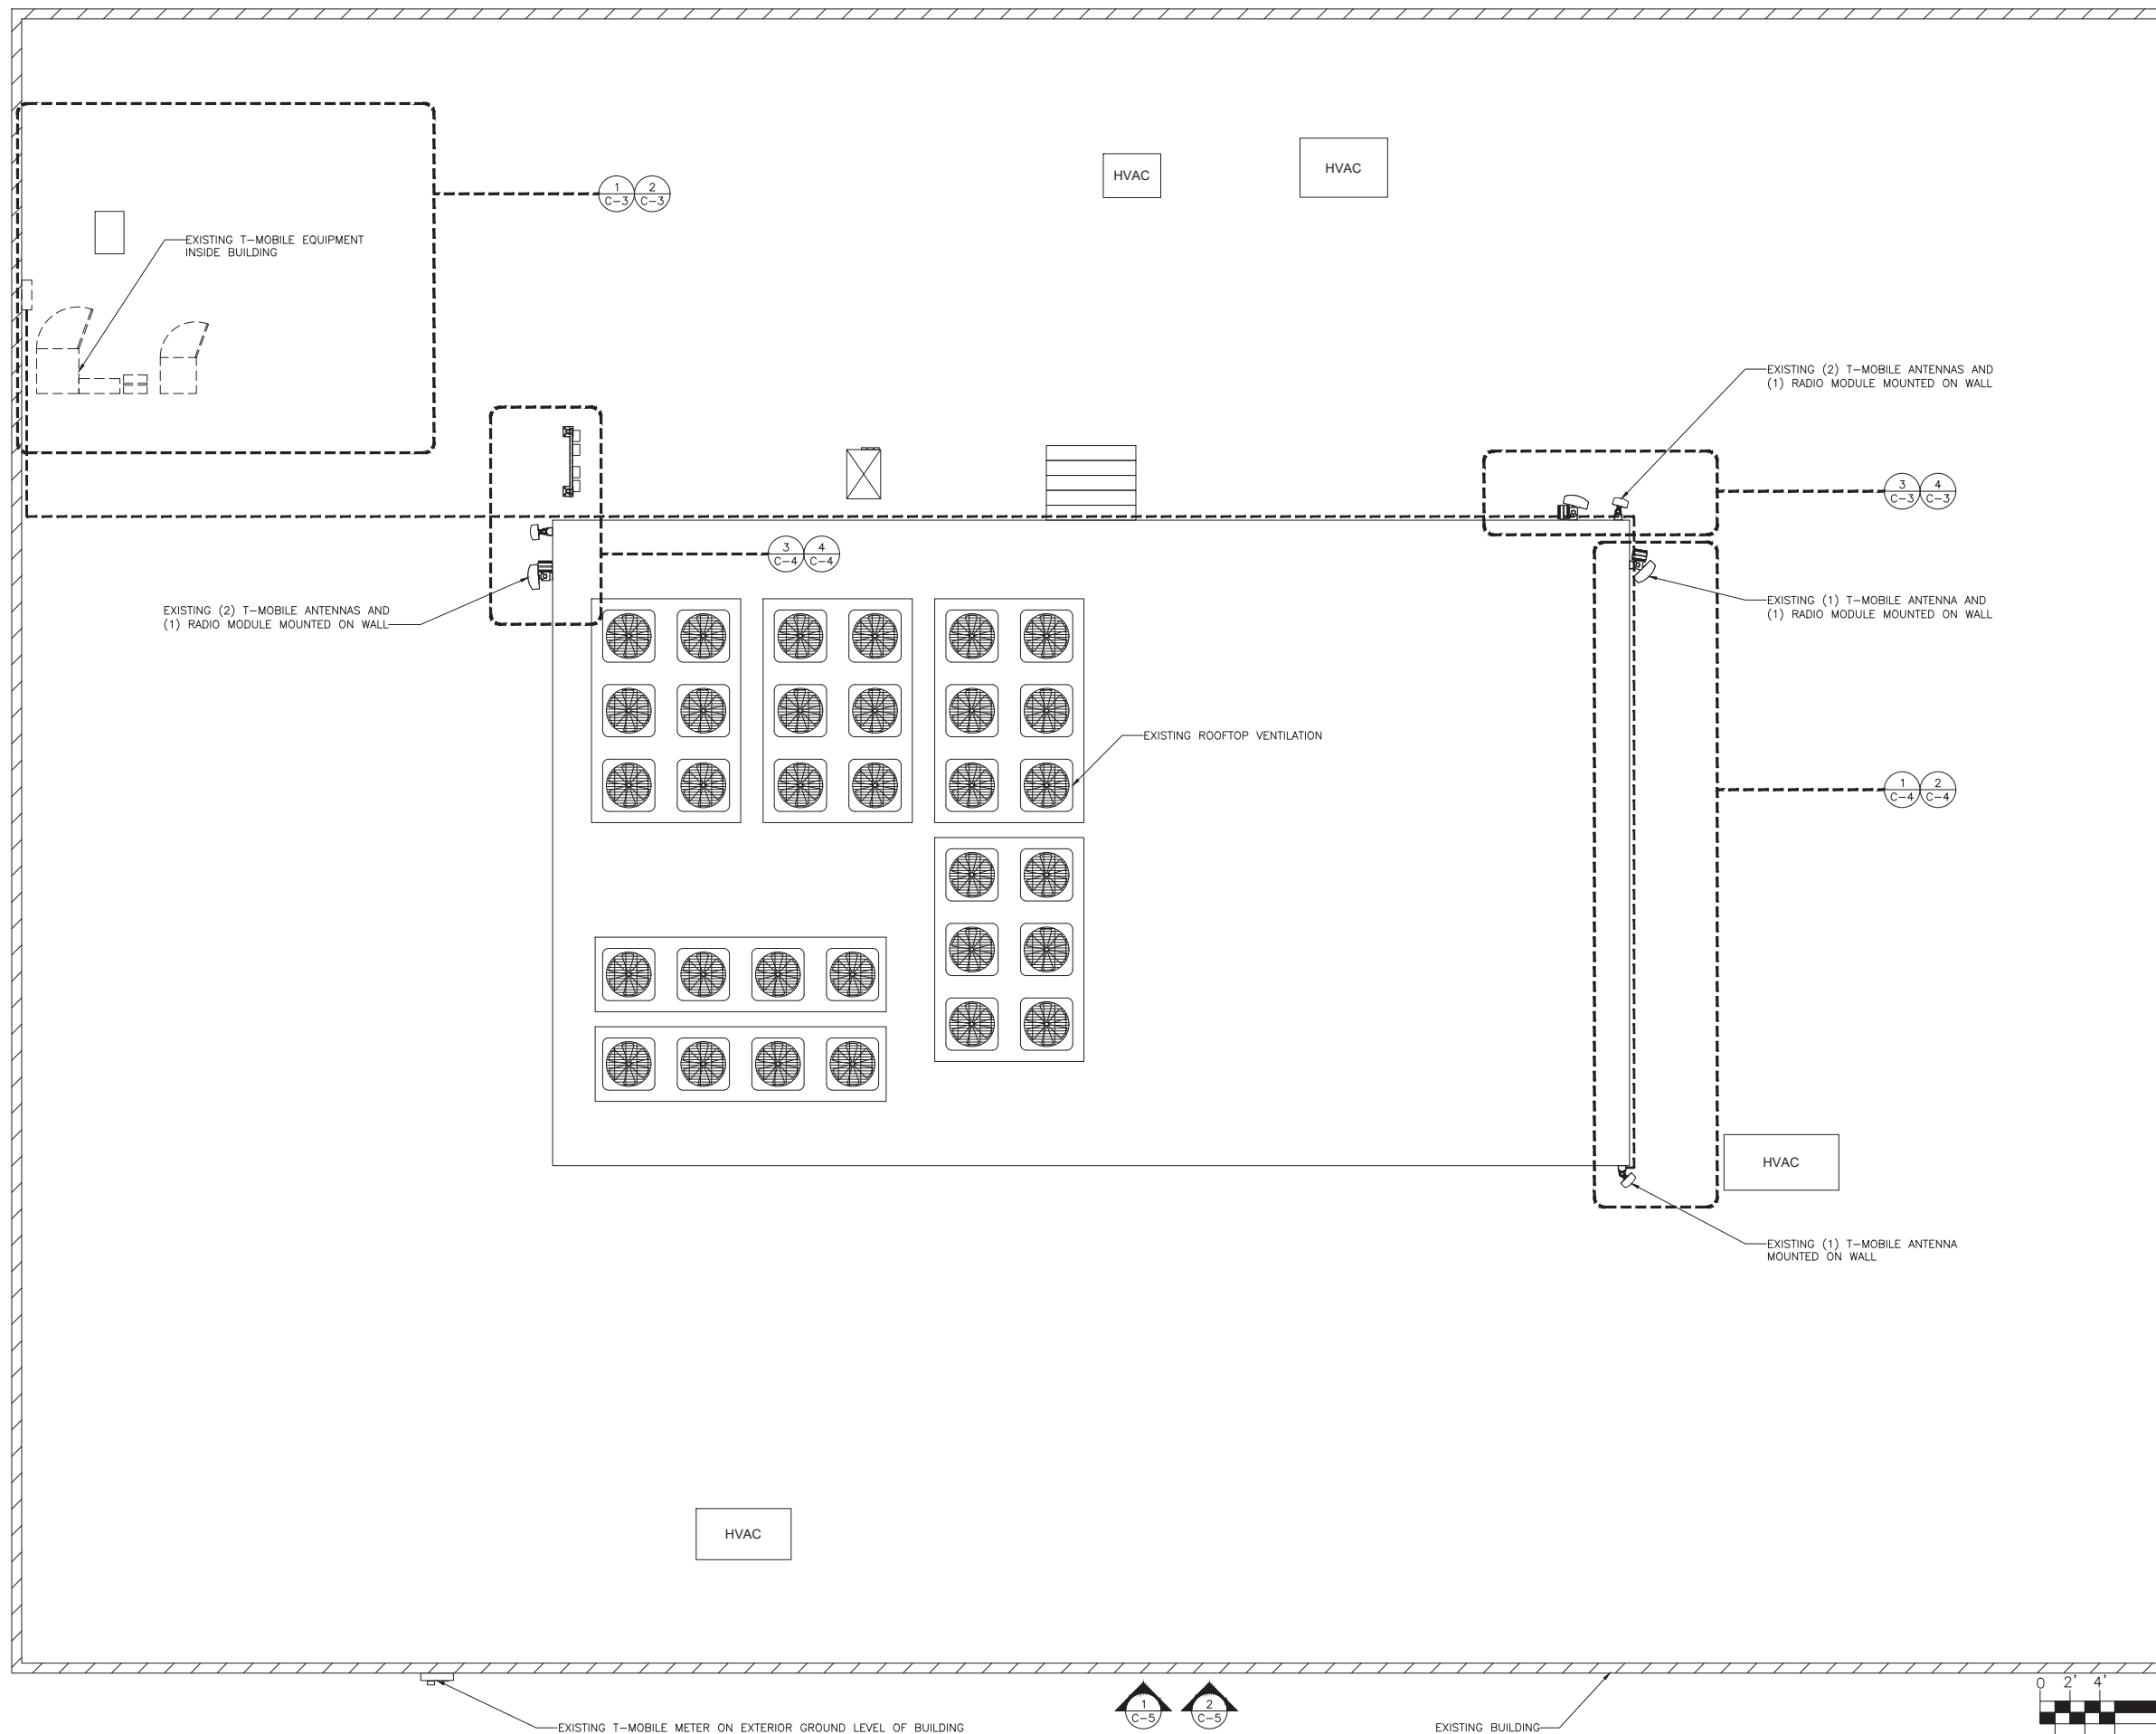
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ENLARGED SITE PLAN

JURISDICTIONAL APPROVAL

SHEET NUMBER
C-2


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EXISTING ANTENNA PLAN

SCALE: 3/4" = 1'-0"

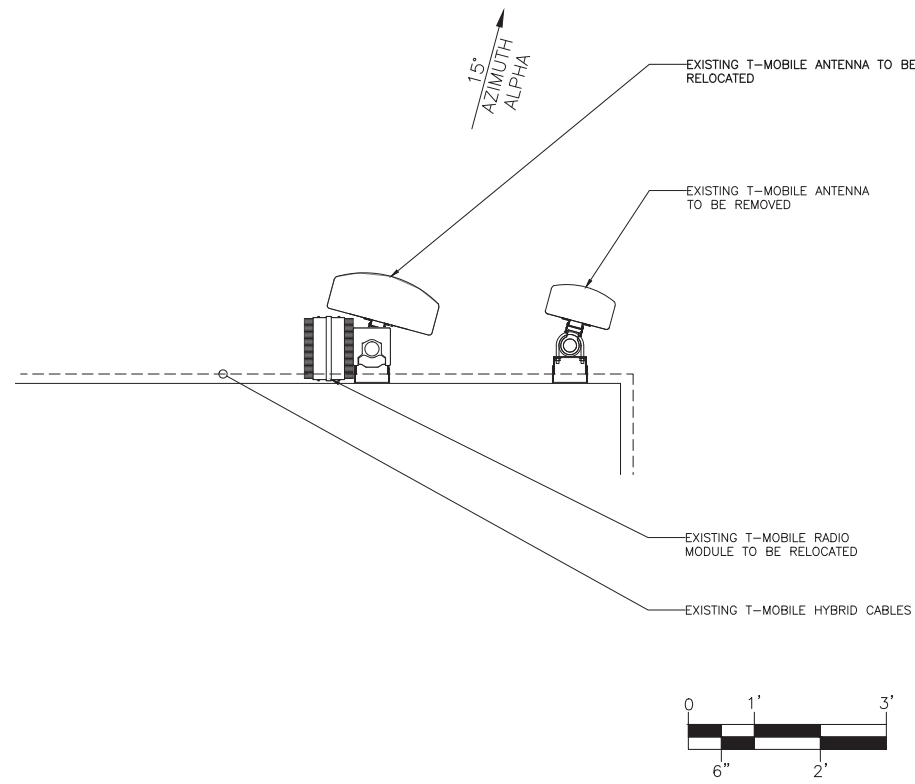
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EXISTING EQUIPMENT PLAN

SCALE: 3/8" = 1'-0"


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NEW ANTENNA PLAN

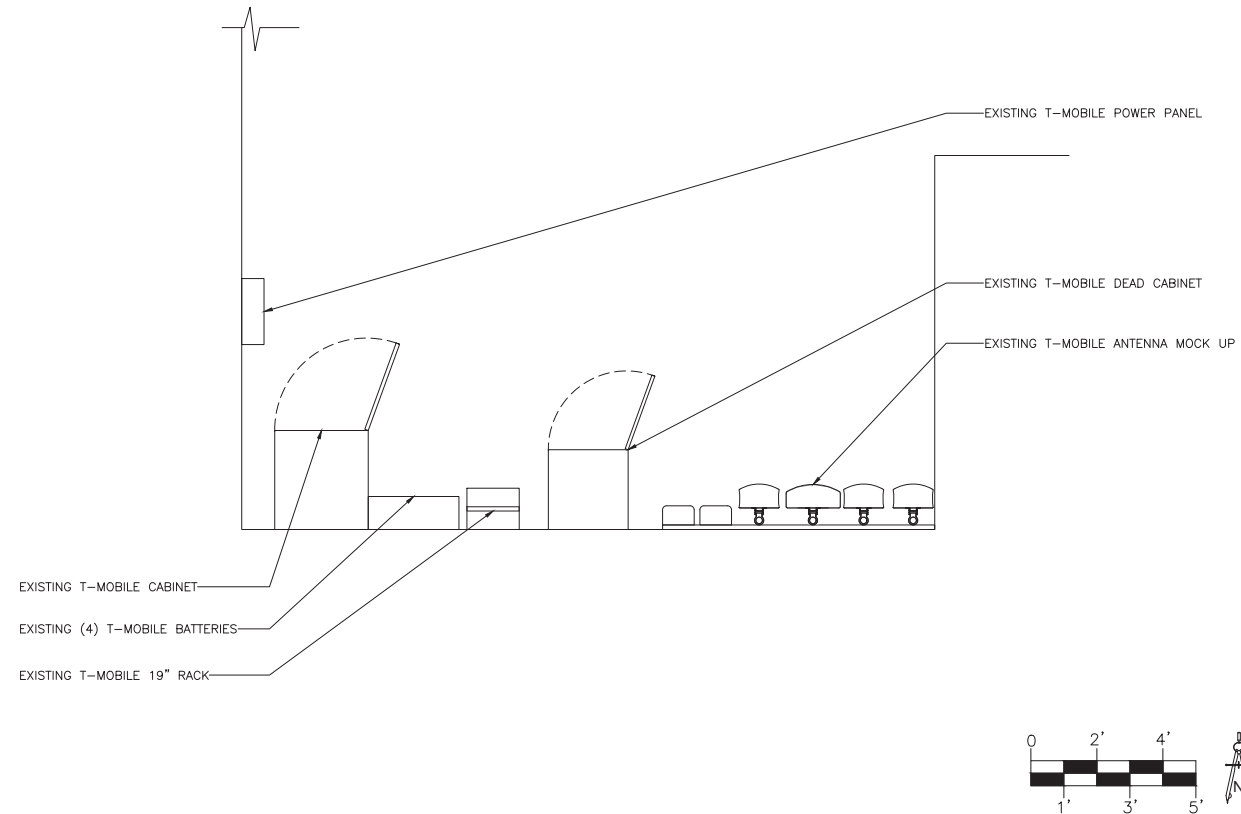SCALE: 1/2" = 1'-0"

4

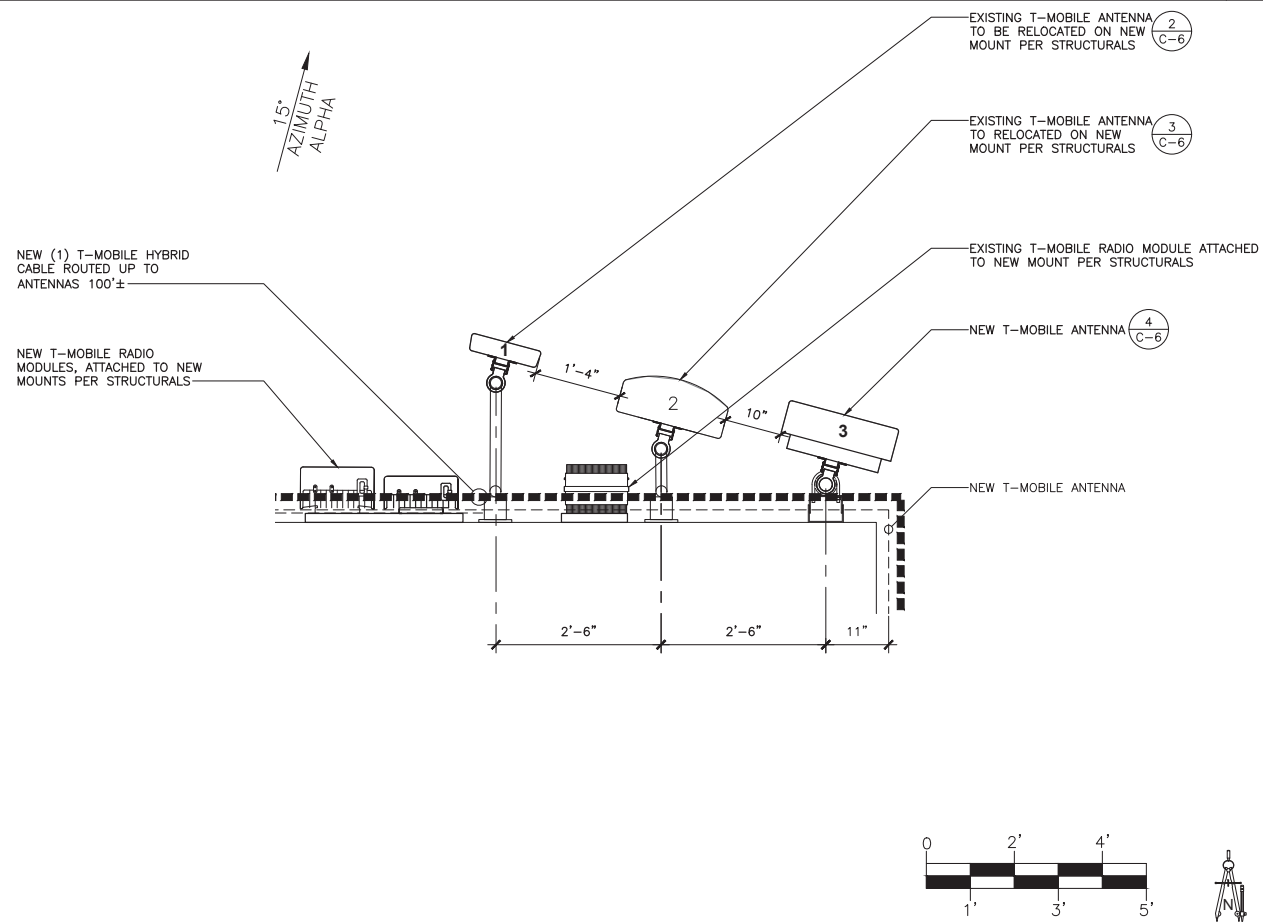

NEW EQUIPMENT PLAN

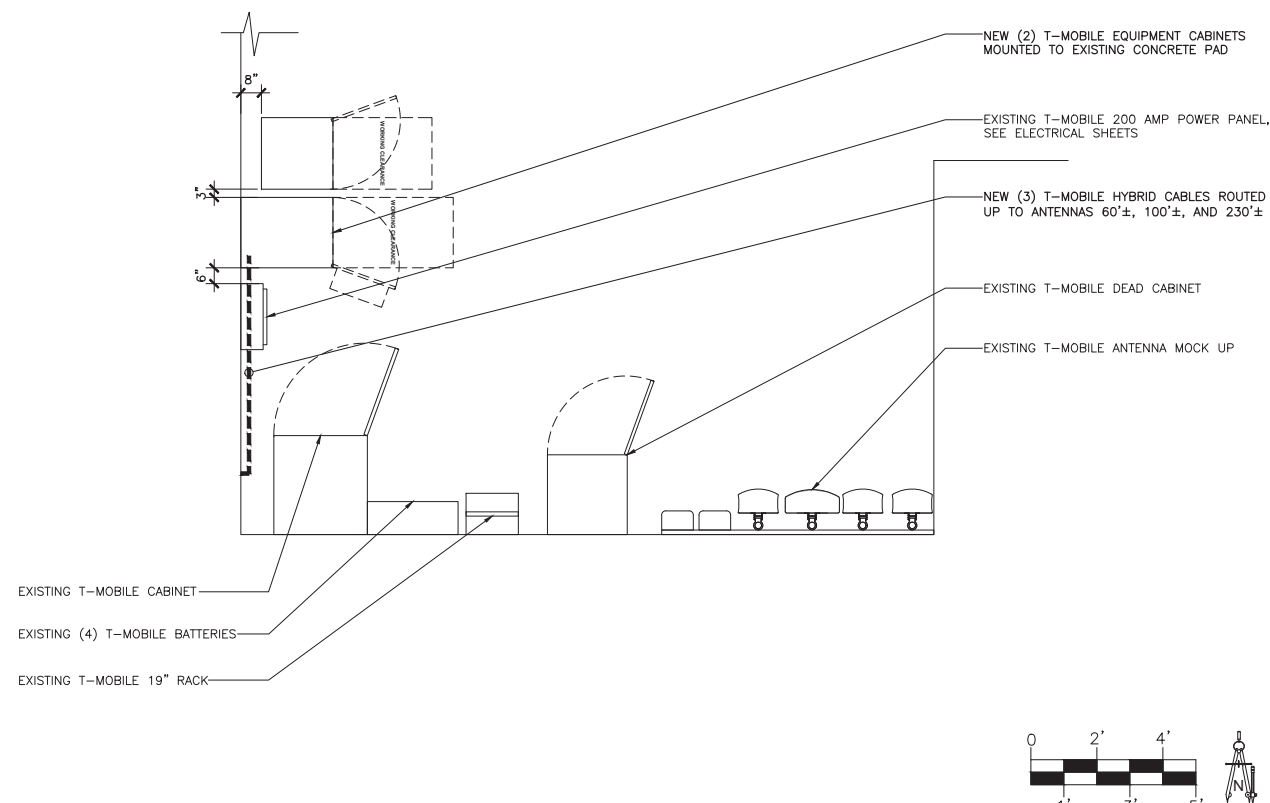SCALE: 3/8" = 1'-0"

2

CLIENT
T-Mobile
 121 ELECTION RD.
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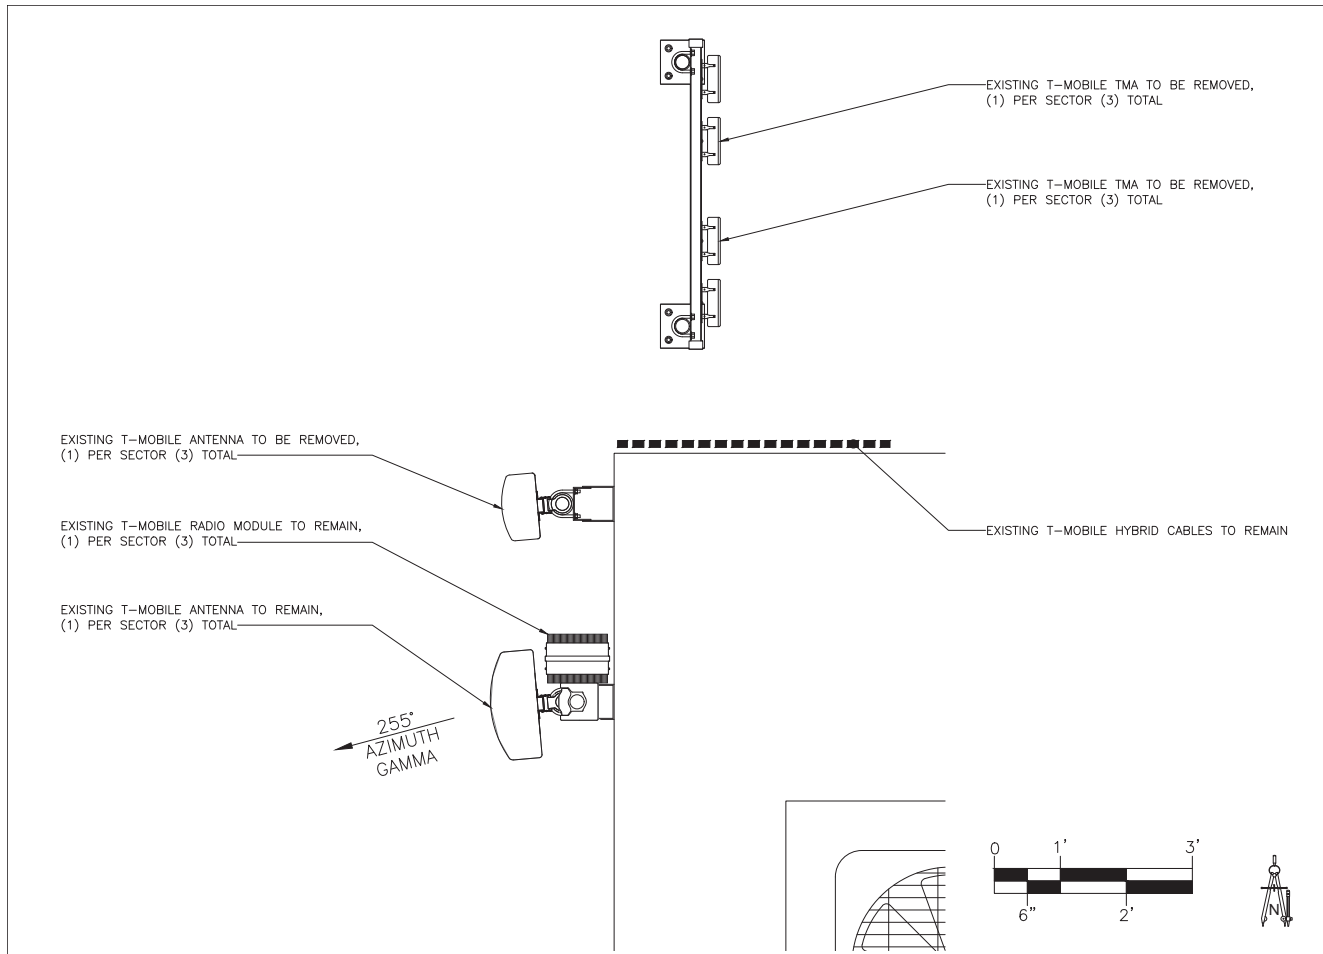
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SHEET TITLE
**EXISTING/NEW
 ANTENNA PLAN**


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SHEET NUMBER
C-3


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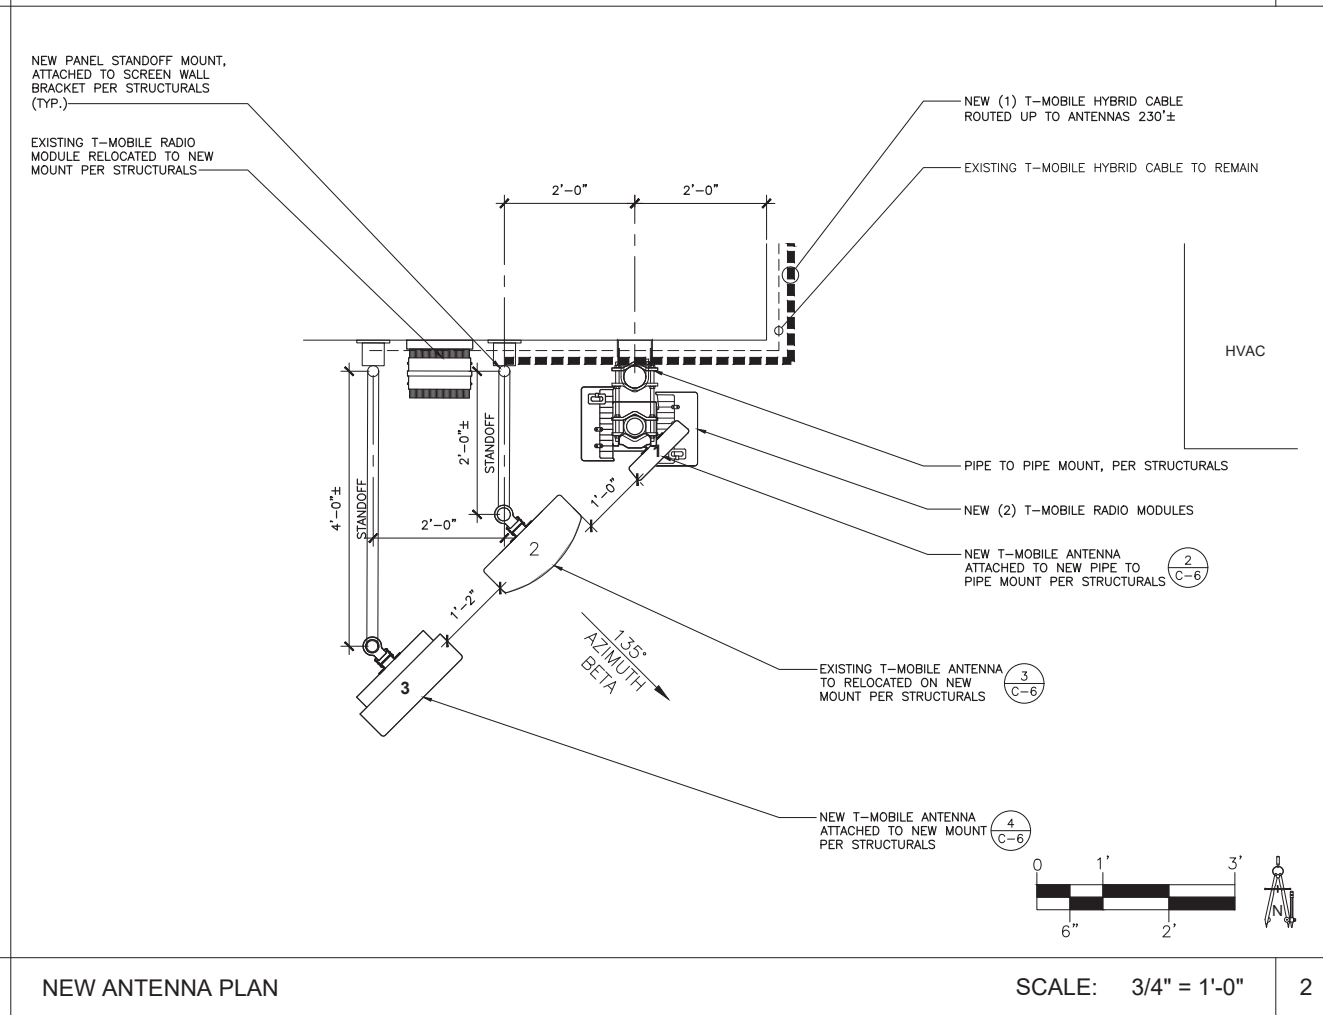
EXISTING ANTENNA PLAN SCALE: 3/4" = 1'-0" 3



EXISTING ANTENNA PLAN SCALE: 3/4" = 1'-0" 1

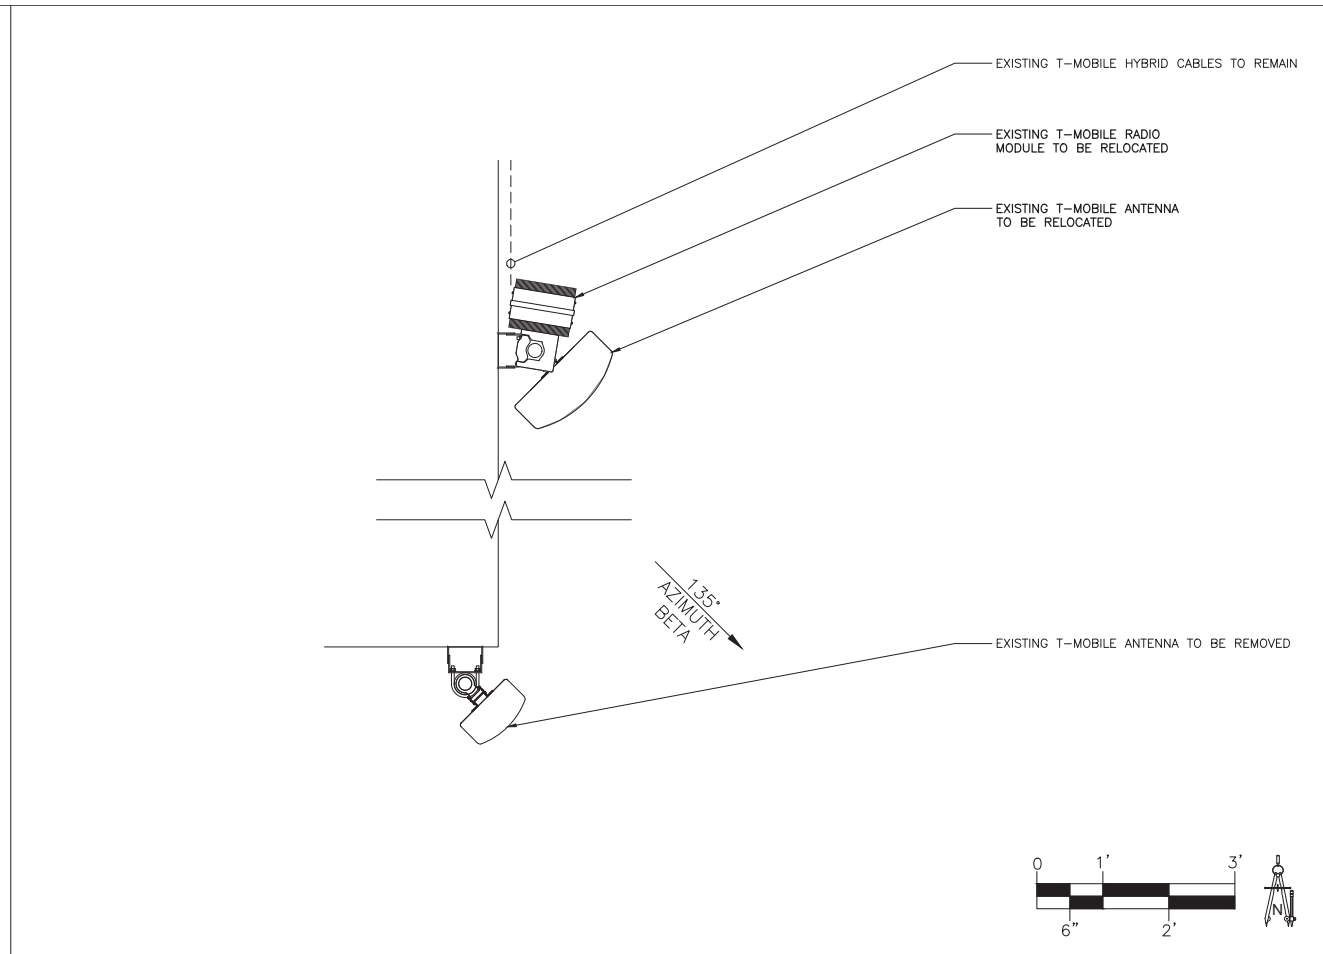

NEW ANTENNA PLAN SCALE: 1/2" = 1'-0" 4

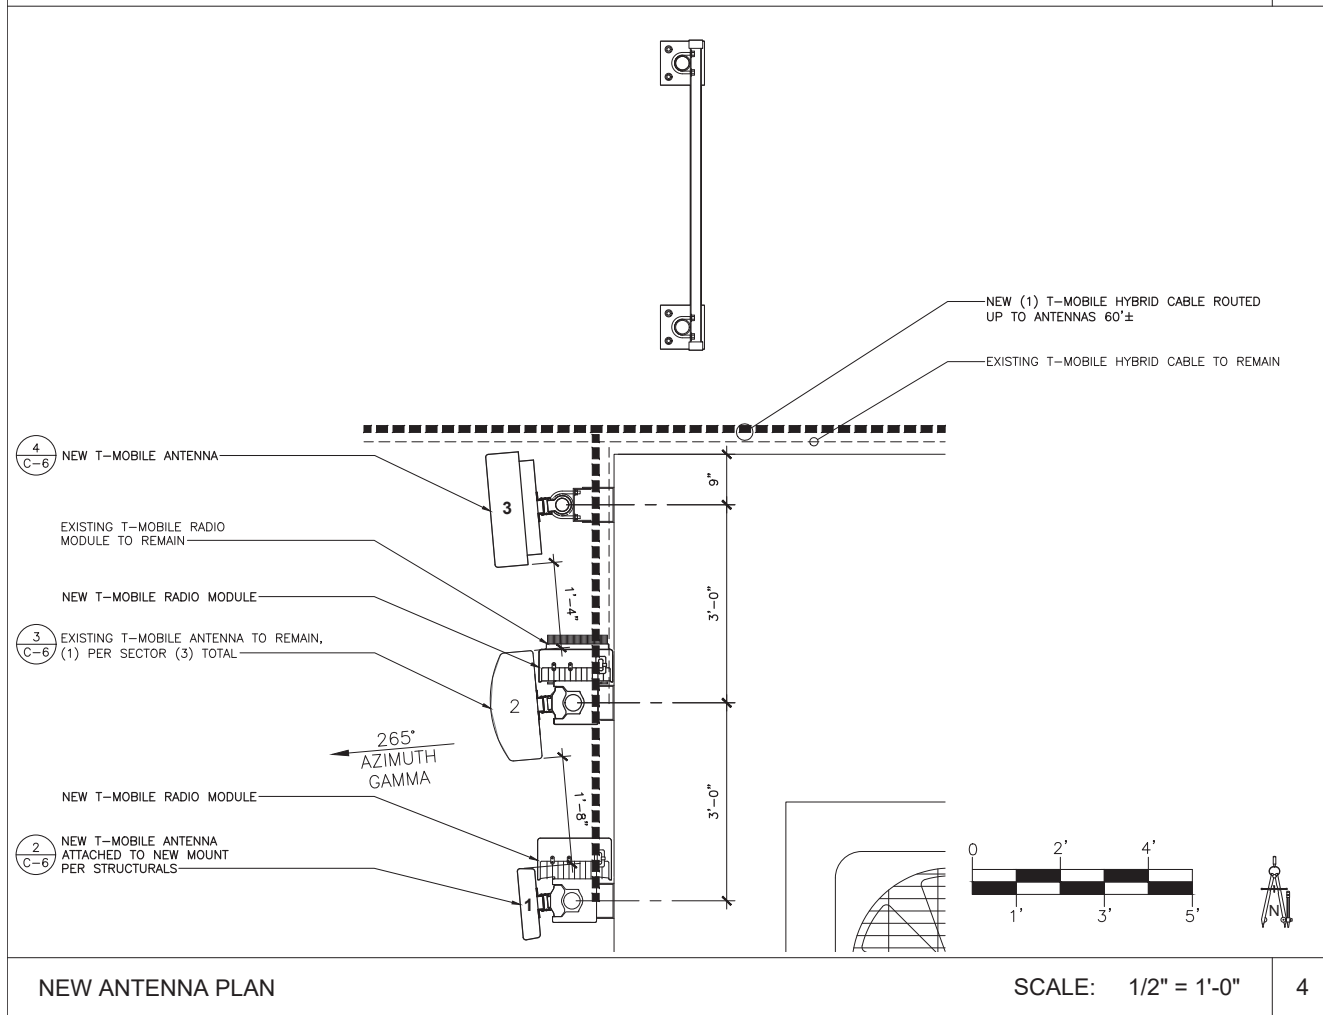

NEW ANTENNA PLAN SCALE: 3/4" = 1'-0" 2

CLIENT

T-Mobile

121 ELECTION RD.
DRAPER, UTAH 84020

CONSULTANT

COAL CREEK CONSULTING

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ENGINEER OF RECORD

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DRAPER SWITCH**

268 W 12300 S
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SHEET TITLE

**EXISTING/NEW
ANTENNA PLAN**

JURISDICTIONAL APPROVAL

SHEET NUMBER

C-4

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CLIENT



121 ELECTION RD.
DRAPER, UTAH 84020

CONSULTANT



2166 E. UNIVERSITY DR., STE 201
TEMPE, ARIZONA 85281
PHONE: (602) 429-0533 FAX: (480) 638-2852


ENGINEER OF RECORD

TERRA DYNAMIC ENGINEERING, LLC



P.O. BOX 22131, PHOENIX, AZ 85028
PHONE: (602) 482-1803
EMAIL: ROBERT@TERRADYNAMIC.US

SEAL


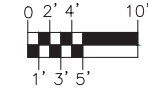


EXISTING SOUTH ELEVATION

SCALE: 1/8" = 1'-0"

NO.	DATE	DESCRIPTION	BY
1	09/03/20	REVIEW	JM
2	11/13/20	REVISION 1	REW

NOTES:
STRUCTURAL ANALYSIS MUST BE PERFORMED BEFORE INSTALLATION OF ANY NEW ANTENNAS. STRUCTURAL ANALYSIS PROVIDED BY OTHERS.

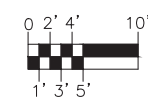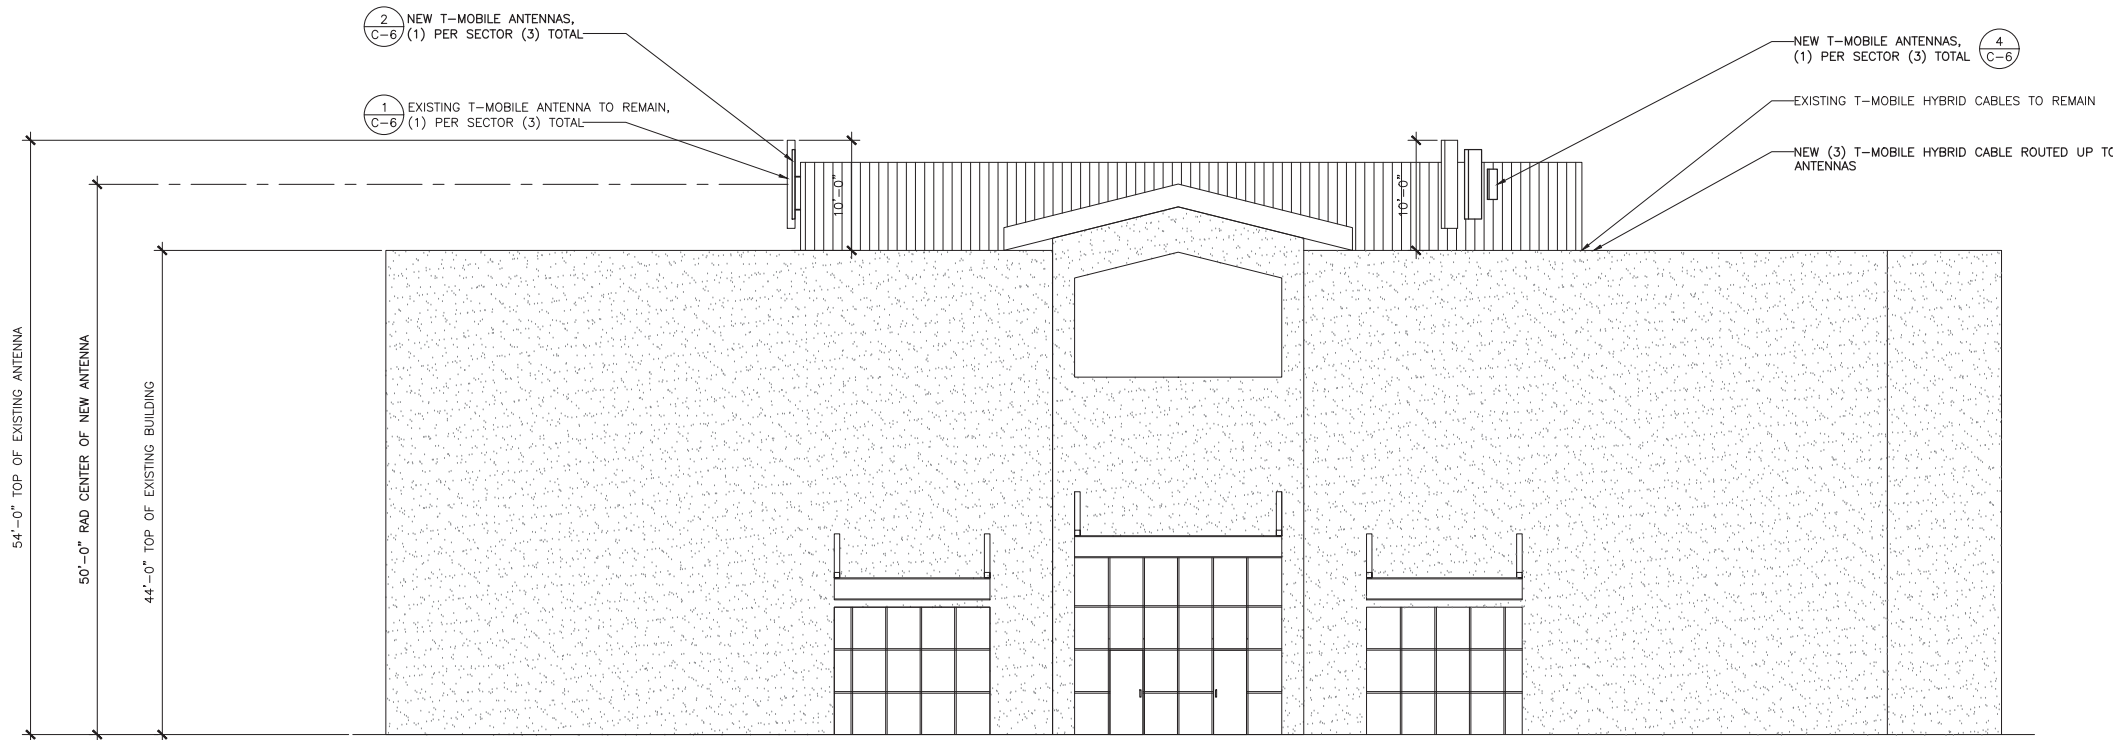

NEW SOUTH ELEVATION

SCALE: 1/8" = 1'-0"

PROJECT INFORMATION
JOB: 13-057-04

SL03000A
DRAPER SWITCH

268 W 12300 S
DRAPER, UTAH 84020

SHEET TITLE

EXISTING/NEW
ELEVATIONS

JURISDICTIONAL APPROVAL

SHEET NUMBER

C-5

RFDS VER: 5 DATED 8/5/2020 7:14:14 PM




ANTENNA AND CABLE SCHEDULE										
SECTOR	ANT. POS. #	ANTENNA TYPE	RAD CENTER	AZIMUTH	MECHANICAL DOWN TILT	ELECTRICAL DOWN TILT	CABLE TYPE	# OF LINES	LENGTH	RADIO
ALPHA	1	RFS - APX17DWV-17DWV-S-E-A20 (QUAD)	49'±	15°	0	4	7/8" COAX	4		ERICSSON-4415-B66A
ALPHA	2	RFS-APXVAARR24_43-U-NA20 (OCTO)	49'±	15°	0	6 AND 4	6X12 HCS	1 1	60M± 70M±	ERICSSON-4449-B71+B85 ERICSSON-4424-B25
ALPHA	3	ERICSSON-AIR6449 B41 (MASSIVE MIMO)	49'±	15°	0	4				
BETA	1	RFS - APX17DWV-17DWV-S-E-A20 (QUAD)	49'±	135°	0	4	7/8" COAX	4		ERICSSON-4415-B66A
BETA	2	RFS-APXVAARR24_43-U-NA20 (OCTO)	49'±	135°	0	6 AND 4	6X12 HCS	1 1	80M± 80M±	ERICSSON-4449-B71+B85 ERICSSON-4424-B25
BETA	3	ERICSSON-AIR6449 B41 (MASSIVE MIMO)	49'±	135°	0	4				
GAMMA	1	RFS - APX17DWV-17DWV-S-E-A20 (QUAD)	49'±	265°	2	4	7/8" COAX	4		ERICSSON-4415-B66A
GAMMA	2	RFS-APXVAARR24_43-U-NA20 (OCTO)	49'±	265°	2	6 AND 4	6X12 HCS	1 1	30M± 30M±	ERICSSON-4449-B71+B85 ERICSSON-4424-B25
GAMMA	3	ERICSSON-AIR6449 B41 (MASSIVE MIMO)	49'±	265°	2	4				

NO.	DATE	DESCRIPTION	BY
1	09/03/20	REVIEW	JM
2	11/13/20	REVISION 1	REW

ANTENNA SCHEDULE

SCALE: N.T.S.

1

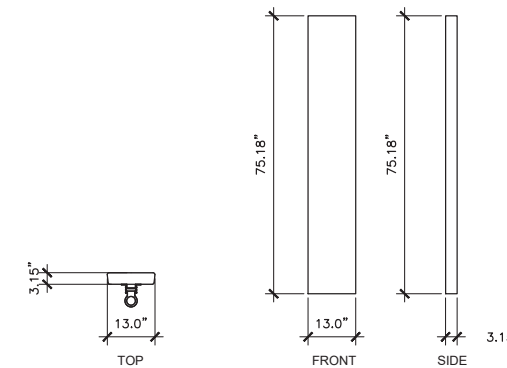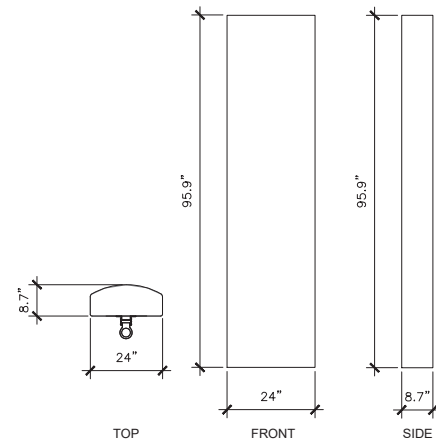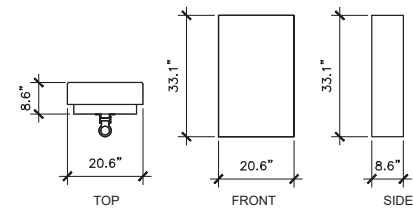

PROJECT INFORMATION
 JOB: 13-057-04

**SL03000A
 DRAPER SWITCH**

268 W 12300 S
 DRAPER, UTAH 84020

SHEET TITLE

DETAILS

JURISDICTIONAL APPROVAL

SHEET NUMBER

C-6

NOT USED

SCALE: N.T.S.

5

NEW ANTENNA #2

SCALE: N.T.S.

4

NEW ANTENNA #1

SCALE: N.T.S.

3

EXISTING ANTENNA #1

SCALE: N.T.S.

2

RFDS VER: 5 DATED 8/5/2020 7:14:14 PM