

Development Review Committee 1020 East Pioneer Road Draper, UT 84020

STAFF REPORT

December 10, 2024

To: Jennifer Jastremsky, Zoning Administrator

Approved

Date

From: Todd Taylor, Planner III 801-576-6510, todd.taylor@draperutah.gov

Re:	<u>General RV – Site</u>	<u>Plan Amendment Request</u>				
	Application No.:	2024-0190-SP				
	Applicant:	Justin Nye, NWL Architects, representing South Minuteman Drive,				
		LC				
	Project Location:	14295 S. Minuteman Drive				
	Current Zoning:	CR (Regional Commercial) Zone				
	Acreage:	4.92 Acres (Approximately 214,315 ft ²)				
	Request:	Request for approval of a Site Plan Amendment in the CR zone				
		regarding an addition to the General RV building and				
		reconfiguration of the parking lot.				

SUMMARY AND BACKGROUND

This application is a request for approval of a Site Plan Amendment on approximately 4.92 acres located at 14295 S. Minuteman Drive (Exhibit B & C). The property is currently zoned CR. The applicant is requesting that a Site Plan Amendment be approved to allow for the construction of a 2,837 ft² addition to the existing General RV building and the reconfiguration of the parking lot. The existing building is 20,746 ft². It was originally built in 2005 and an addition to the RV service bay was completed in 2011.



<u>ANALYSIS</u>

<u>General Plan and Zoning</u>.

Table 1	General Plan and Zoning Designations	Exhibit
Existing Land Use	Regional Commercial	Exhibit D
Current Zoning	CR	Exhibit E
Current Use	RV Sales and Service	
Adjacent Zoning		
East	RM2 (Multiple-Family Residential)	
West	N/A (I-15 Freeway)	
North	CO2 (Professional Office)	
South	CR	

The Regional Commercial land use designation is characterized as follows:

Regional Commercial

LAND USE DESCRIPTIO	N
CHARACTERISTICS	 Include a wide range of commercial uses that combine destination oriented businesses, retail commercial, entertainment and related uses Include uses that serve both residents and nonresidents of the City Uniform design standards and aesthetics Well landscaped street frontages Limited traffic access points for the site
LAND USE MIX	 Large-scale master-planned commercial centers Big box centers Upscale office buildings
COMPATIBLE ZONING	Regional Commercial (CR)
LOCATION	 Excellent transportation access to major highways Strategically placed along high-traffic corridors

According to Draper City Municipal Code (DCMC) Section 9-8-020 the purpose of the CR Zone is to *"provide areas where a combination of destination oriented business, retail commercial, entertainment, and related uses may be established, maintained and protected to serve both residents and nonresidents of the city. Typical uses in this zone include large scale, master planned commercial centers with outlying commercial pads, big box stores, and offices."*

<u>Site Plan Layout</u>. The Site Plan (Exhibit F) shows that the one-story, 2,837 ft² building addition will be located to the west and south of the existing two-story building, towards the center of the parcel. It is located approximately 105 feet from the nearest exterior parcel line,



exceeding all setback requirements. The building addition impacts some of the existing parking. Parking and landscaping modifications occur to the west of the addition, and are discussed in subsequent sections of this staff report.

<u>Landscaping</u>. The Landscape Plan (Exhibit G) shows that 2,958 ft² of landscaping is proposed to be added at the front of the building and within the parking lot. There is 40,720 ft² of existing landscaping along both street frontages and along the south and east property lines. The areas of the parking lot that have been modified will be brought into compliance with the parking lot landscaping standards by adding landscaped islands at the end of each row and between rows of stalls. The disturbance area does not propose to modify the existing perimeter landscaping, buffers, or street trees.

Table 2	Landscaping Design Requirements			
Standard	DCMC Requirements	Proposal	Notes	
Overall Landscaping Coverage	20% min.	20%		
Parking Lot Landscaping	7% min.	7%		
Perimeter Landscaping	10 feet min.	16-31 feet (approx.)	Perimeter is within existing landscaping.	
Buffer Landscaping	N/A	N/A		
Water Wise Landscaping	No lawn on slopes 25% or greater or areas less than 8 feet wide.	N/A	No lawn is proposed.	

<u>Parking</u>. The Site Plan (Exhibit F) shows that the parking lot will be modified near the entry of the building, and new parking will be added along the western portion of the parking lot adjacent to Minuteman Drive. The RV sales and service uses on the site will require 84 parking stalls to be provided. The modified parking lot will contain 76 stalls, which is within the ten percent (10%) natural adjustment range of 76-93 allowed.

Table 3	Parking Lot Design Req	uirements	
Standard	DCMC Requirements	Proposal	Notes
Parking Required (Min/Max)			
RV Sale	29-35		
RV Service	47-58		
Total	76 -93	76	Complies with ordinance.
Pedestrian Connections			



Cross Walks	Different material from parking lot required	Colored concrete paving	Complies with ordinance.
Access Point Width	24-26 feet	N/A	No change proposed.

<u>Architecture</u>. The Elevations (Exhibit H) show the proposed design of the approximately twenty-nine foot (29') tall addition. The primary materials are split faced concrete masonry unit (CMU), aluminum composite metal panels, and brick. Smooth faced CMU will also be incorporated into the facade. The CMU and the brick will be color matched to the existing materials, and the aluminum composite metal panels will be provided in two (2) colors.

Table 4 Architectural Design Requirements			
Standard	DCMC Requirements	Proposal	Notes
Building Height			
Main Building	35 feet max.	29 feet (approx.)	
Facade Variation			
Vertical or Horizontal	Every 30 feet, or along 60% of the horizontal length for buildings with facades 100 feet or greater.	Variations occur in the surface pattern and banding.	
Significant	One significant variation of 5 feet deep by 20 feet wide for buildings with facades 100 feet or greater.	N/A	No facade 100 feet in length or greater is proposed.
Materials	0		
Primary	2 min.	3 (split faced CMU, aluminum composite metal panels, and brick).	
Secondary	N/A	EIFS	
Percentage of Primary	Materials		
North	75% min.	97%	
West	75% min.	80%	
South	75% min.	76%	
East	75% min	N/A	Attached to existing building on east.



Lighting. The Lighting Plan (Exhibit I) shows that ten (10) new building-mounted lighting fixtures will be added to the site. The proposed new lighting fixtures are low enough in intensity that they meet both the operational hours and after-hours illumination standards. Additionally, three (3) of the new building-mounted lighting fixtures will turn off at the close of business each night. All other lighting fixtures, including the light poles are existing.

Table 5	Lighting Design Require	ments	
Standard	DCMC Requirements	Proposal	Notes
Light Pole Height	20 feet max.	N/A	No new light poles proposed.
Foot Candles			
Maximum	25.0 fc	14.1 fc	
Illumination	15.0 fc (after hours)		
Maximum	15.0 fc	3.8 fc	
Average	10.0 (after hours)		
Illumination			
Maximum	5:1	3.71:1	
Illumination Ratio	5:1 (after hours)		
(Max:Ave)			

<u>*Criteria For Approval*</u>. The criteria for review and potential approval of a Site Plan Amendment request are found in Sections 9-5-060(E) and (H) of the Draper City Municipal Code. This section depicts the standard of review for such requests as:

- *E. Standards For Approval: The following standards shall apply to the approval of a site plan:*
 - *1. The entire site shall be developed at one time unless a phased development plan is approved.*
 - 2. A site plan shall conform to applicable standards set forth in this title, including but not limited to, building heights, setbacks, access points, parking, landscaping, and building materials.
 - *3. The proposed development plans meet the intent, goals, and objectives of the general plan and the purpose of the zone district in which the site is located.*
 - *4. The public facilities and services in the area are adequate to support the subject development, as required by engineering standards and specifications.*
 - 5. The proposed development plans comply with the engineering standards found in Titles 7, 8, 11, 12, 16, and 18 of this code, including traffic, storm water drainage, and utilities concerns.



- *H. Amendments: Except as may be provided for in this section, no element of an approved site plan shall be changed or modified without first obtaining approval of an amended site plan as follows:*
 - 1. Alteration or expansion of an approved site plan may be permitted by the Zoning Administrator upon making the following findings:
 - a. The proposed use is consistent with uses permitted on the site;
 - *b.* Existing uses were permitted when the site plan was approved, or have received a conditional use permit;
 - *c.* The proposed use and site will conform to applicable requirements of this Code;
 - *d.* The proposed expansion meets the approval standards of subsection *E* of this section;
 - *e.* The site can accommodate any change in the number of people on the site or any change in impact on surrounding infrastructure; and
 - 2. If the Zoning Administrator cannot make the findings required in this subsection H, the amended site plan may only be approved by the Planning Commission. The Planning Commission may only approve an amended site plan after a public hearing that complies with all requirements of this code, including section 9-5-045.
 - *3. If the Zoning Administrator can make all findings required in this subsection H the Zoning Administrator may approve the proposed amendment without a public hearing and without notice.*
 - *4. Properties that do not conform to the standards found within this code may be required to come into compliance, subject to the standards in 9-6-040, 9-6-050, 9-6-060, and 9-6-070 of this title.*

<u>REVIEWS</u>

<u>Planning Division Review</u>. The Draper City Planning Division has completed their review of the Site Plan Amendment submission. Comments from this division, if any, can be found in Exhibit A.

<u>Engineering and Public Works Divisions Review</u>. The Draper City Engineering and Public Works Divisions have completed their reviews of the Site Plan Amendment submission. Comments from these divisions, if any, can be found in Exhibit A.

Building Division Review. The Draper City Building Division has completed their review of the Site Plan Amendment submission. Comments from this division, if any, can be found in Exhibit A.

<u>Fire Division Review</u>. The Draper City Fire Marshal has completed his review of the Site Plan Amendment submission. Comments from this division, if any, can be found in Exhibit A.



Noticing. A notice of decision will be issued as outlined in City and State Codes.

STAFF RECOMMENDATION

Staff finds that the application complies with the DCMC and recommends that the Zoning Administrator review the request and approve the application based on the findings listed below and the criteria for approval, as listed within the staff report.

If the Zoning Administrator decides to approve the request, staff recommends they include the following conditions of approval:

- 1. That all requirements of the Draper City Engineering, Public Works, Building, Planning, and Fire Divisions are satisfied throughout the development of the site and the construction of all buildings on the site, including permitting.
- 2. That all requirements of the geotechnical report are satisfied throughout the development of the site and the construction of all buildings on the site.
- 3. That a long term (onsite) storm drainage maintenance plan and agreement be submitted, reviewed, and accepted prior to issuance of a Land Disturbance Permit or Building Permit.

Findings for approval:

- 1. The site plan reflects the full development of the property.
- 2. The site plan conforms to applicable standards set forth in ordinance, including but not limited to, building heights, setbacks, access points, parking, landscaping, and building materials.
- 3. The proposed development plans meet the intent, goals, and objectives of the general plan and the purpose of the zoning districts in which the site is located.
- 4. The public facilities and services in the area are adequate to support the subject development, as required by engineering standards and specifications.
- 5. The proposed development plans will comply with the engineering standards found in Titles 7, 8, 11, 12, 16, and 18 of the DCMC, including traffic, storm water drainage, and utilities concerns.



DEVELOPMENT REVIEW COMMITTEE ACKNOWLEDGEMENT

We, the undersigned, as duly appointed members of the Draper City Development Review Committee, do acknowledge that the application which provides the subject for this staff report has been reviewed by the Committee and has been found to be appropriate for review by the Draper City Planning Commission and/or City Council.

Brien Maxfield

Draper City Public Works Department

Don Buckley Don Buckley Dol Taper City Fire Department, OU=Fire Marshal, CN=Don Buckley Date: 2024.12.03 13:38:06-07'00'

Draper City Fire Department

Matthew Symes DN: C=US, E-matt.symes@draperutah.gov, 0=Draper City Corp., CN-Matthew Symes Date: 2024.12.03 13:44:25-0700'

Draper City Building Division

ally signed by Todd A Draper DN: C=US. E=todd.drat O=Draper 0 CN=Todd.4 Todd A. Draper **Draper City Planning Division** Draper City Legal Counse

EXHIBIT A DEPARTMENT REVIEWS

REVIEWS ARE NOT MEANT TO BE AN ALL INCLUSIVE LIST OF POSSIBLE COMMENTS OR CONDITIONS.

Planning Division Review.

1. No additional comments provided.

Engineering and Public Works Divisions Review.

1. Long term (onsite) storm drainage maintenance plan and agreement are required. Plan and agreement will be a conditional of site plan amendment approval and are required to be submitted, reviewed, and accepted prior to issuance of Land Disturbance Permit or Building Permit.

Building Division Review.

1. No additional comments provided.

<u>Fire Division Review.</u>

1. No additional comments provided.

EXHIBIT B VICINITY MAP

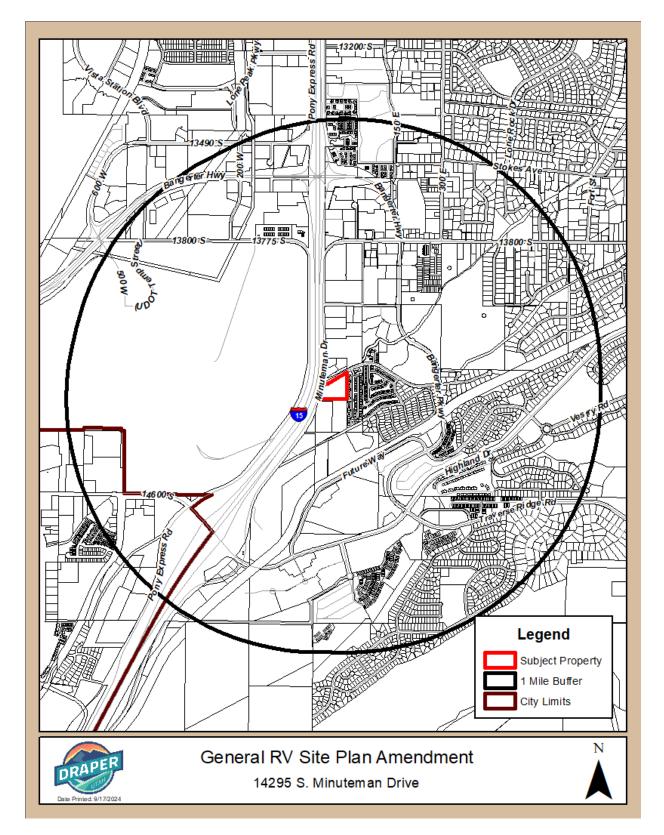


EXHIBIT C AERIAL MAP



EXHIBIT D LAND USE MAP

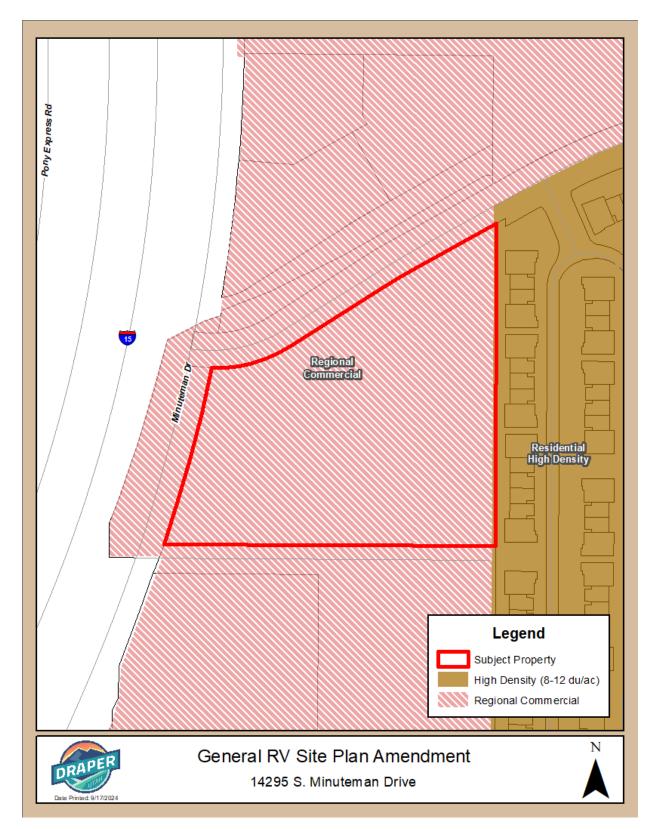


EXHIBIT E ZONING MAP

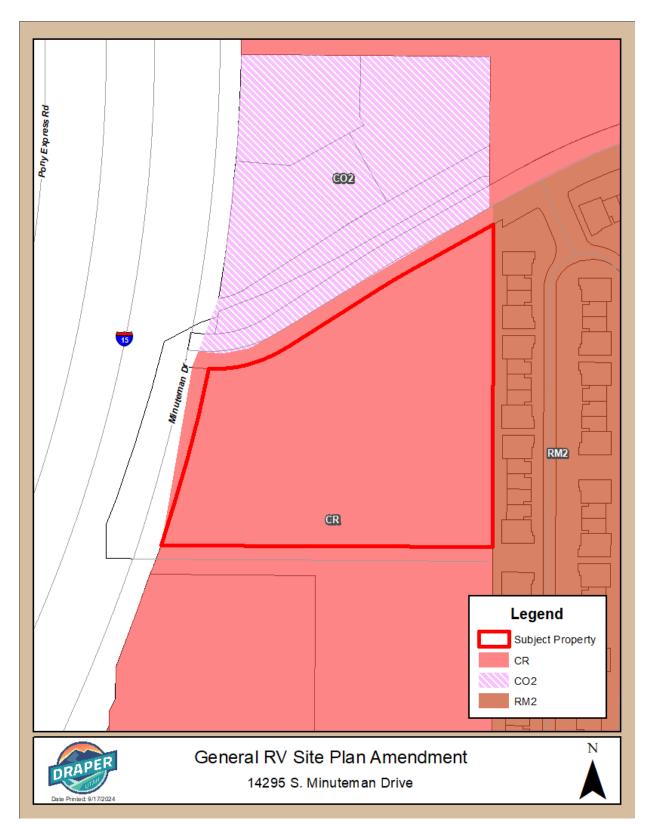


EXHIBIT F SITE PLAN



NAYLOR WENTWORTH LUND ARCHITECTS 723 W Pacific Avenue, Suite 101 Salt Lake City, UT 84104 Main Office 801.355.5959

Stamp

— 4'' GALVANIZE STANDARD PIPE FILLED WITH CONCRETE

Project Number Project Issue Date August 20, 2024


Sheet Title Site Development Plan


SD101


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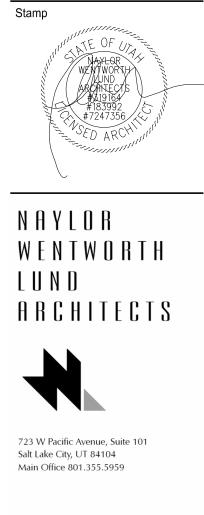


14295 Minuteman Dr. Draper, UT 84020



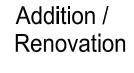

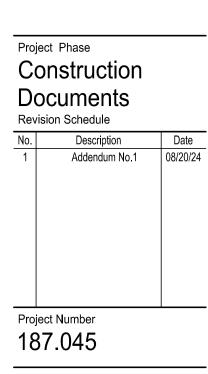


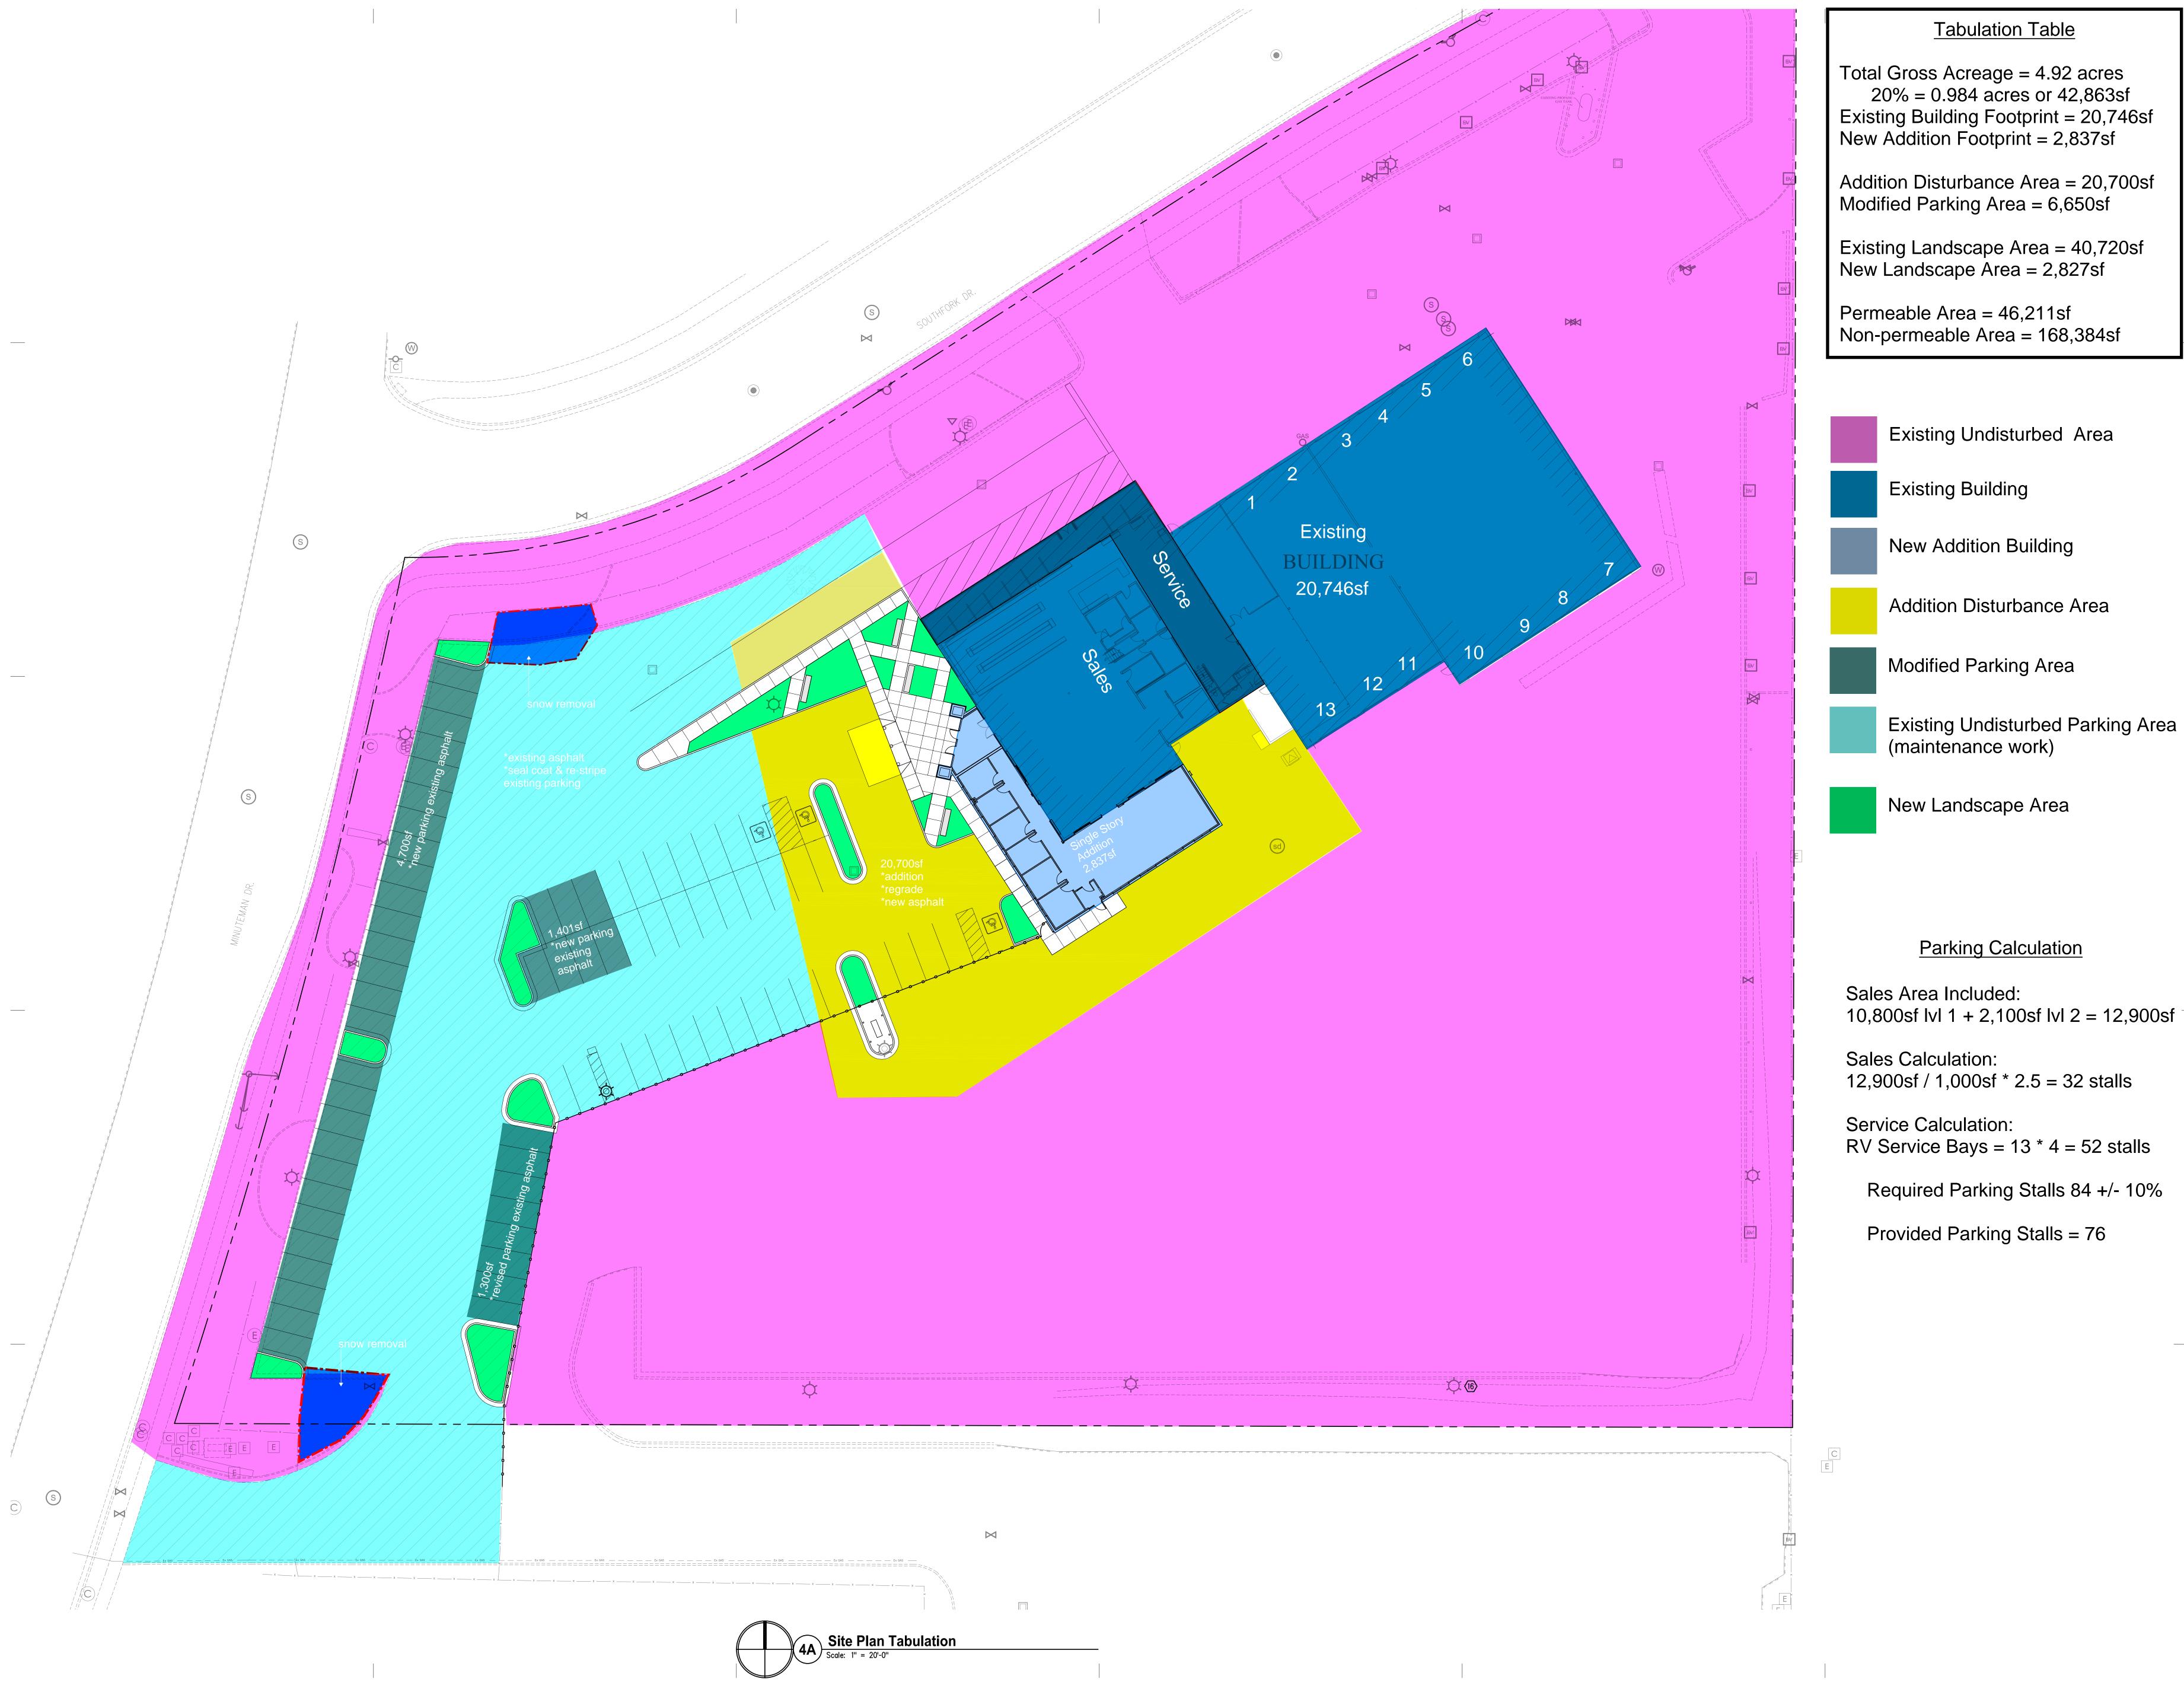




GENERAL RV CENTER 14295 Minuteman Dr. Draper, UT 84020

Addition / Renovation

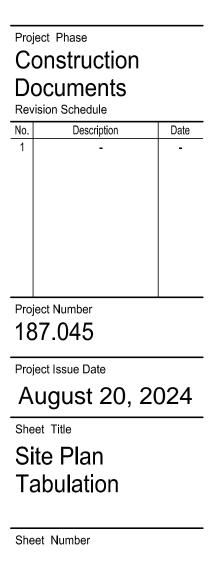

SD102


EXHIBIT G LANDSCAPE PLAN

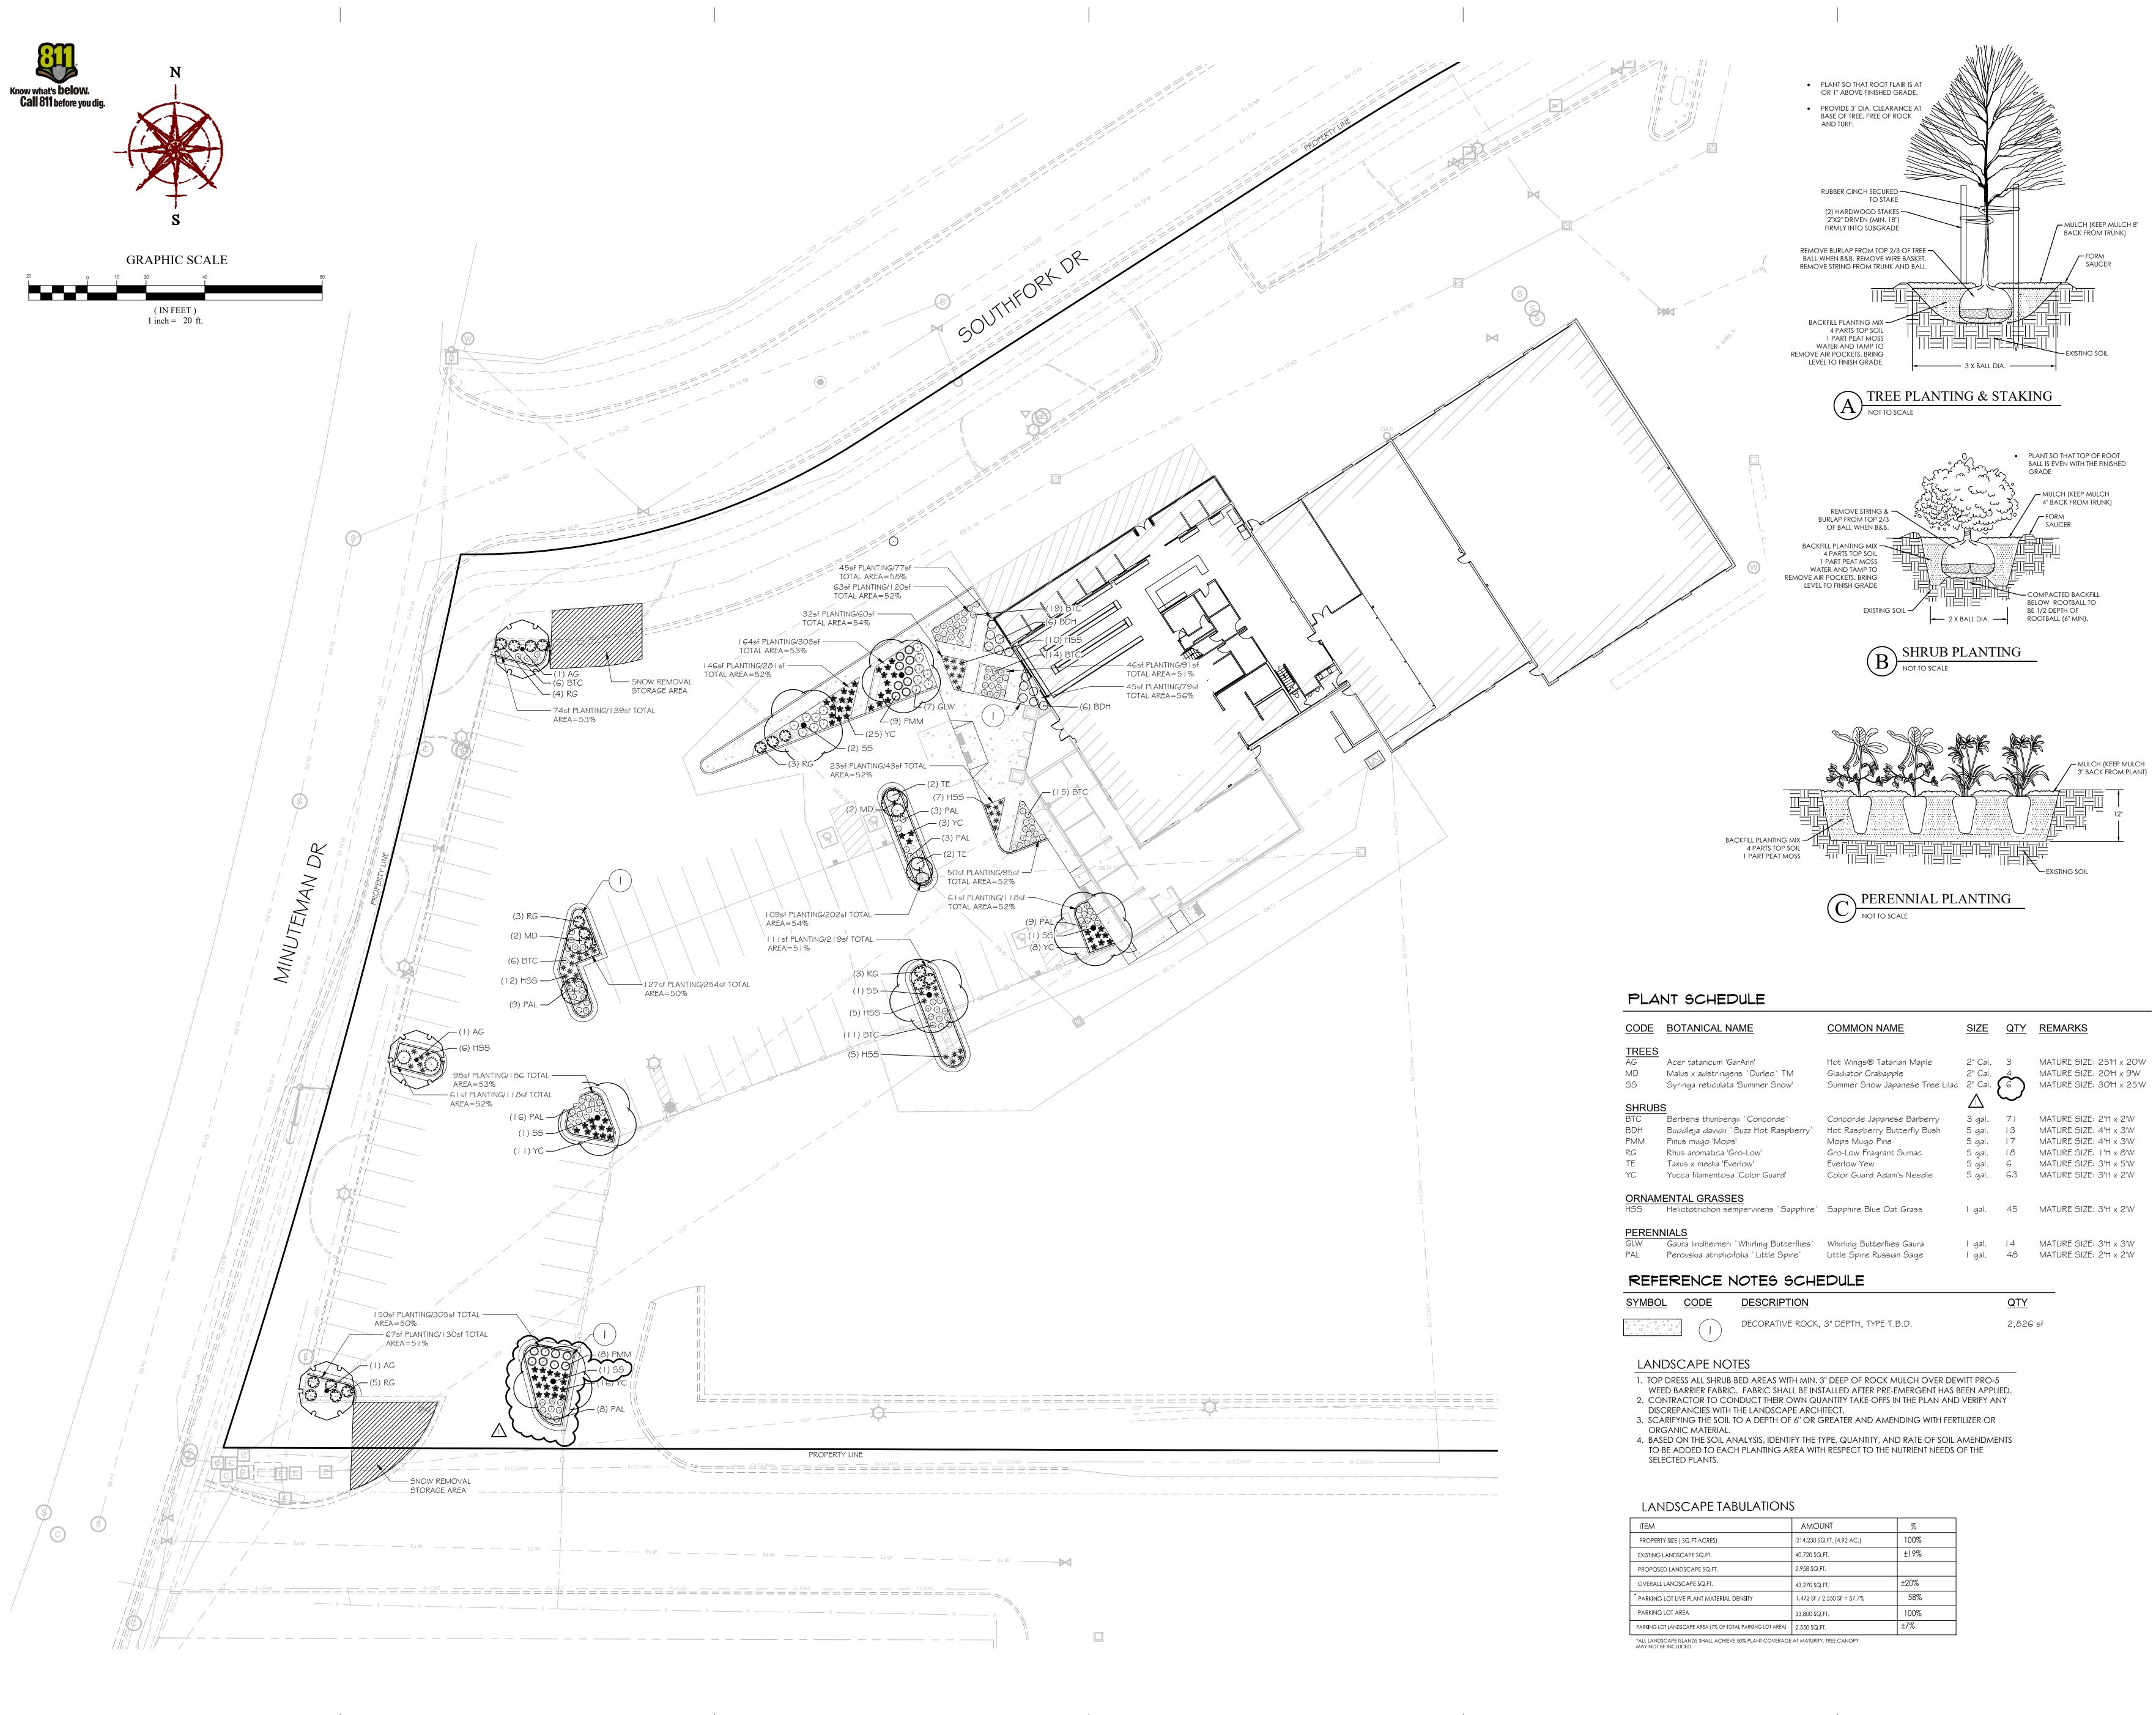

CODE	BOTANICAL NAME	COMMON NAME	<u>SIZE</u>	<u>QTY</u>	<u>REMARKS</u>
TREES					
AG	Acer tatarıcum 'GarAnn'	Hot Wings® Tatarian Maple	2" Cal.	3	MATURE SIZE: 2
MD	Malus x adstringens `Durleo` TM	Gladiator Crabapple	2" Cal.	4	MATURE SIZE: 2
55	Syrınga reticulata 'Summer Snow'	Summer Snow Japanese Tree Lilac	2" Cal.	$\left\{ \tilde{c} \right\}$	MATURE SIZE: 3
SHRUB	S		\square	\sim	
BTC		Concorde Japanese Barberry	3 gal.	71	MATURE SIZE: 2
BDH	Buddleja davidii `Buzz Hot Raspberry`	Hot Raspberry Butterfly Bush	5 gal.	13	MATURE SIZE: 4
PMM	Pinus mugo 'Mops'	Mops Mugo Pine	5 gal.	17	MATURE SIZE: 4
RG	Rhus aromatica 'Gro-Low'	Gro-Low Fragrant Sumac	5 gal.	18	MATURE SIZE: 1
TE	Taxus x media 'Everlow'	Everlow Yew	5 gal.	6	MATURE SIZE: 3
YC	Yucca filamentosa 'Color Guard'	Color Guard Adam's Needle	5 gal.	63	MATURE SIZE: 3
ORNAM	IENTAL GRASSES				
HSS	Helictotrichon sempervirens `Sapphire`	Sapphire Blue Oat Grass	l gal.	45	MATURE SIZE: 3
PEREN	NIALS				
GLW	Gaura lindheimeri `Whirling Butterflies`	Whirling Butterflies Gaura	l gal.	14	MATURE SIZE: 3
PAL	Perovskia atriplicifolia `Little Spire`	Little Spire Russian Sage	l gal.	48	MATURE SIZE: 2
REF	ERENCE NOTES SCHE	EDULE			

ITEM	AMOUNT	%
property size (sq.ft, ACRES)	214,230 SQ.FT. (4.92 AC.)	100%
EXISTING LANDSCAPE SQ.FT.	40,720 SQ.FT.	±19%
PROPOSED LANDSCAPE SQ.FT.	2,958 SQ.FT.	
overall landscape sq.ft.	43,270 SQ.FT.	±20%
PARKING LOT LIVE PLANT MATERIAL DENSITY	1,472 SF / 2,550 SF = 57.7%	58%
PARKING LOT AREA	33,800 SQ.FT.	100%
PARKING LOT LANDSCAPE AREA (7% OF TOTAL PARKING LOT AREA)	2,550 SQ.FT.	±7%


0 10399 ALAN K WEAVER 09/17/2024 NAYLOR WENTWORTH LUND ARCHITECTS 723 W Pacific Avenue, Suite 101 Salt Lake City, UT 84104 Main Office 801.355.5959

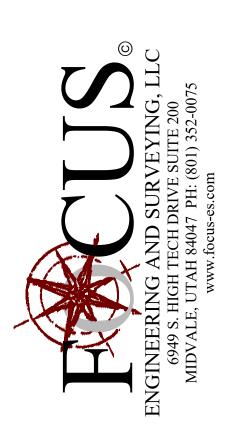




GENERAL RV CENTER 14295 Minuteman Dr. Draper, UT 84020


Addition / Renovation

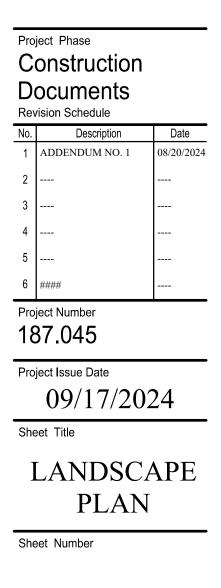

L1.0



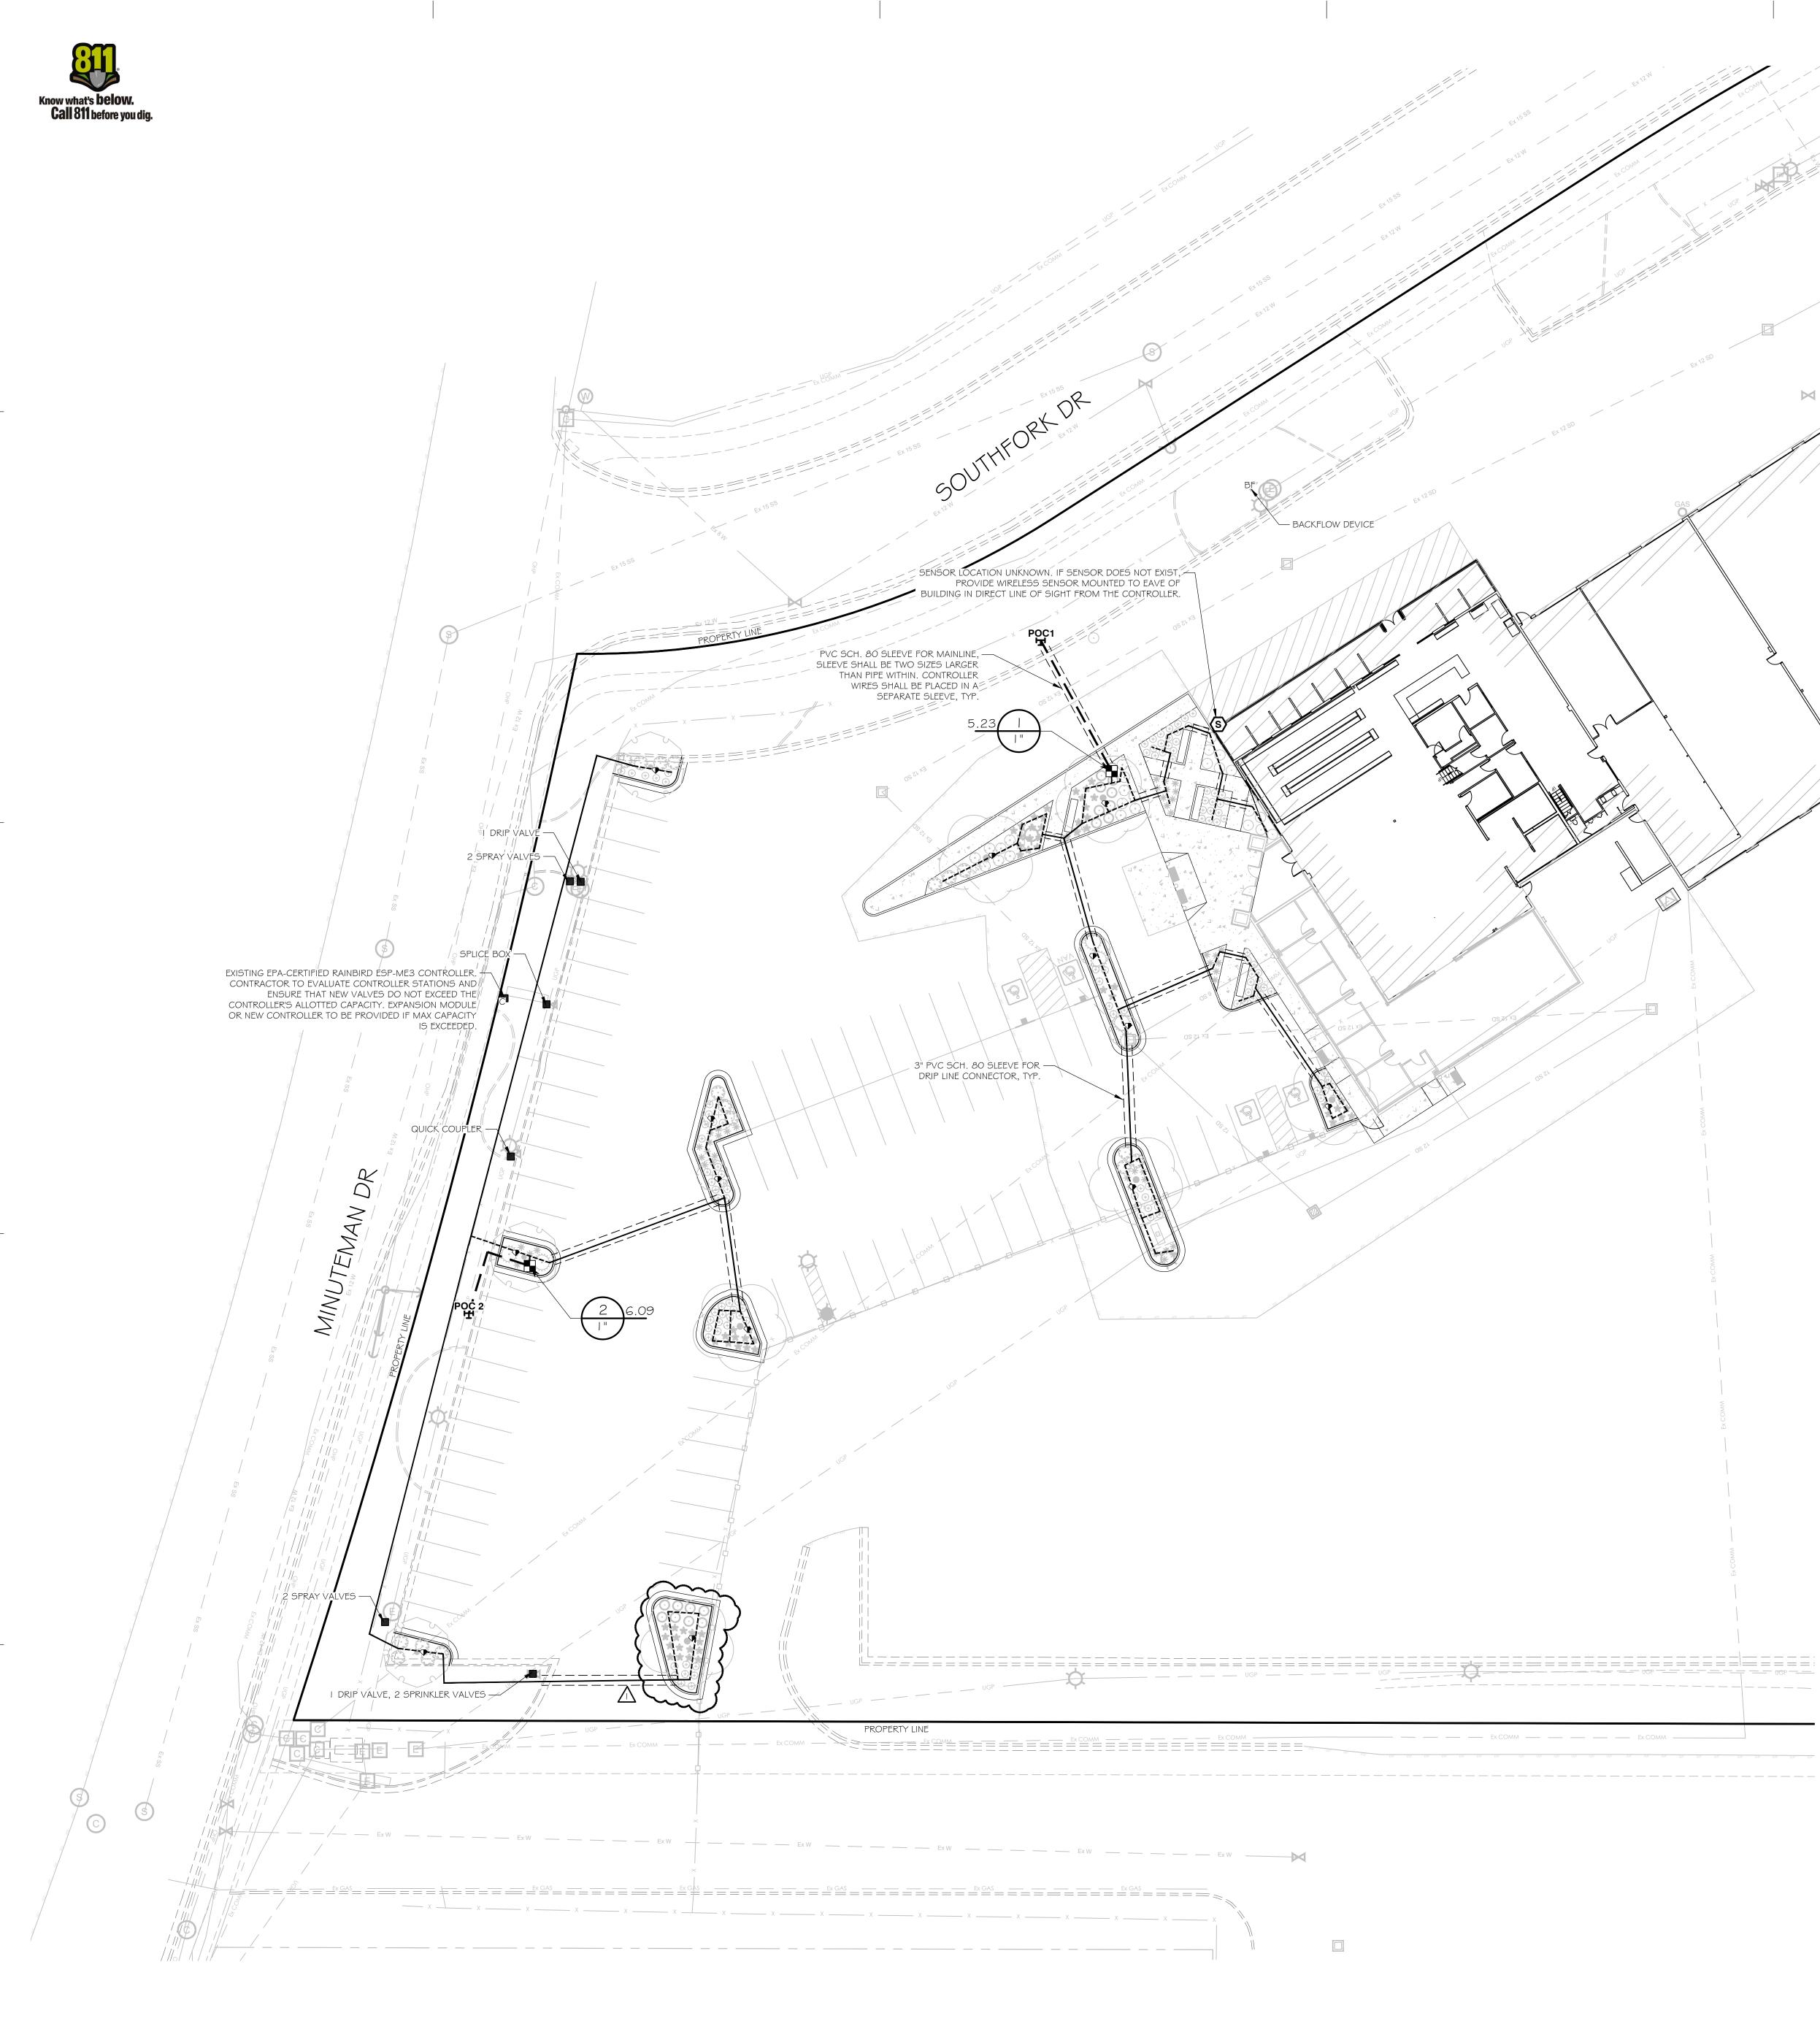

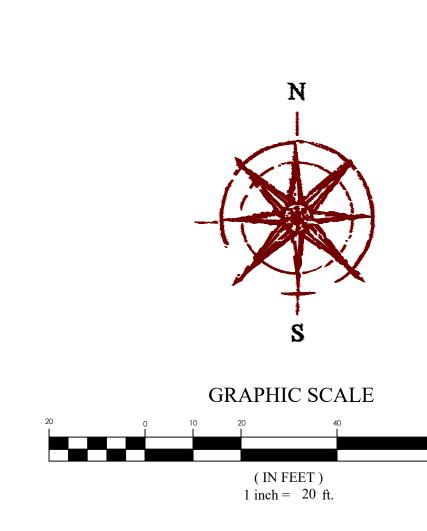

IRRIGATION SCHEDULE

SYMBOL	MANUFACTURER/MODEL/DESCRIPTION	QTY
	Rain Bird XCZ-100-PRF 1" Medium Flow Drip Control Kit, 1" DV valve, 1" pressure regulating filter, 40psi pressure regulator. 3 GPM-15 GPM.	2
	Rain Bird XB-6 Six-Outlet, Pressure Compensating, Drip Emitter. Flow rates of 0.5 GPH=blue, 1.0 GPH=black, and 2.0 GPH=red, at each emitter outlet. Comes with Barb Inlet x Barb Outlet.	
SYMBOL	MANUFACTURER/MODEL/DESCRIPTION	QTY
\$	Raın Bırd WR2-RFS Wıreless Raın/Freeze Sensor.	I
POC1	Point of Connection 2"	1
POC 2	Point of Connection 2"	I
	Irrigation Mainline: PVC Schedule 40	73.4 l.f.
======	Pipe Sleeve: PVC Schedule 80 Sleeve shall be two sizes larger than the pipe within. Valve Callout	303.3 I.f.
	Valve Number	
	Valve Flow Valve Size	
	valve Size	
С	EXISTING CONTROLLER	
BF	EXISTING BACKFLOW DEVICE	
	RAINBIRD 3/4" XBS TUBING WITH 1/4" TUBING TO EMITTE	ĒR
\odot	3/4" MANUAL FLUSH VALVE IN 10" ROUND VALVE BOX	

IRRIGATION NOTES

1. THIS SYSTEM IS BASED UPON AN AVAILABLE STATIC PRESSURE OF 50 PSI MINIMUM. PRIOR TO CONSTRUCTION, CONTRACTOR SHALL CONFIRM THE STATIC WATER PRESSURE AND THE SIZE OF THE POINT OF CONNECTION (POC).


2. COORDINATE AND LOCATE ALL EXISTING UTILITIES ON THE SITE PRIOR TO EXCAVATION. 3. THIS PLAN IS DIAGRAMMATIC. SOME EQUIPMENT MAY BE SHOWN IN PAVED AREAS AND BUILDINGS FOR PLAN CLARITY.


4. INSTALL PVC SCHEDULE 80 SLEEVES UNDER ALL PAVED SURFACES WHERE LINES AND CONTROL WIRES CROSS INCLUDING ALL SIDEWALKS. SLEEVE SIZE SHALL BE 2 TIMES LARGER THAN THE LINE. EXTEND 6" BEYOND THE PAVED SURFACE ON EACH SIDE. INSTALL A SEPARATE SLEEVE FOR THE CONTROL WIRES. 5. INSTALL MANUAL DRAIN VALVES AT ALL LOW POINTS ALONG IRRIGATION MAIN LINE AND EACH SIDE OF DRIVEWAY WHERE MAIN LINE CROSSES UNDER.

6. ALL PIPE FITTINGS SHALL BE SCHEDULE 80 ON MAIN LINE. 7. XBS TUBING SHALL BE INSTALLED UNDER ROCK MULCH.

8. INSTALL 3/4" MANUAL FLUSH VALVE IN AN 10" ROUND VALVE BOX AT THE END OF ALL DRIP LINES.

9. DRIP EMITTERS SHALL BE RAINBIRD XB-20PC (2 GPH)XERI-BUG EMITTER, 1 EMITTER PER PLANT FOR PERENNIALS AND ORNAMENTAL GRASSES AND 2 EMITTERS PER PLANT FOR SHRUBS. 10. RAINBIRD MULTI-OUTLET XERI-BUG EMITTER XB-20-6 (12 GPH) SHALL BE USED ON TREES IN PLANTING BEDS WITH DIFFUSER BUG CAP AT ENDS OF TUBING. DISTRIBUTE EMITTERS AROUND ROOTBALL OF TREE.

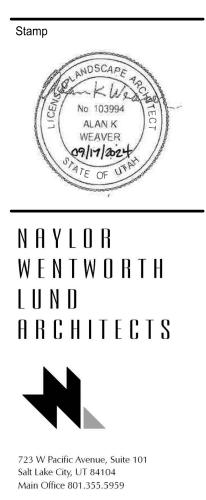


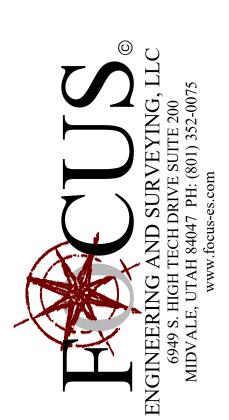




GENERAL RV CENTER 14295 Minuteman Dr. Draper, UT 84020


Addition / Renovation

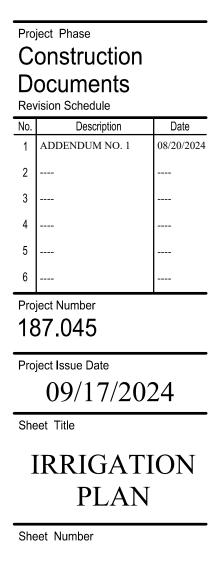

L2.0




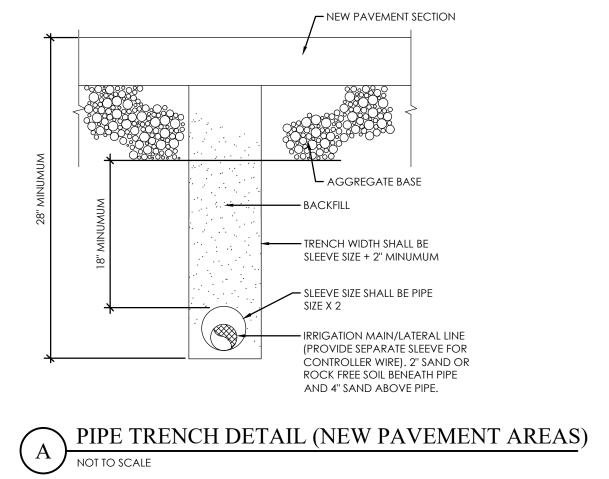

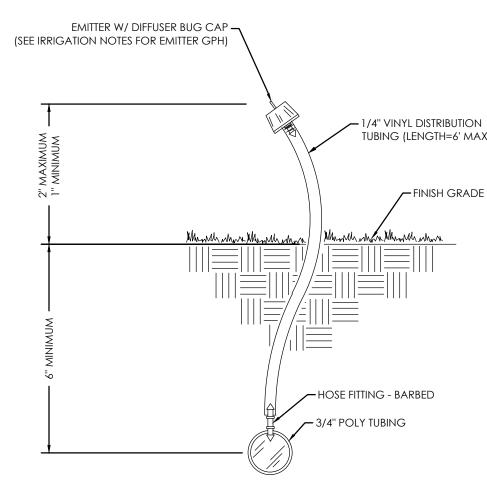






(PROVIDE SEPARATE SLEEVE FOR CONTROLLER WIRE). 2" SAND OR ROCK FREE SOIL BENEATH PIPE

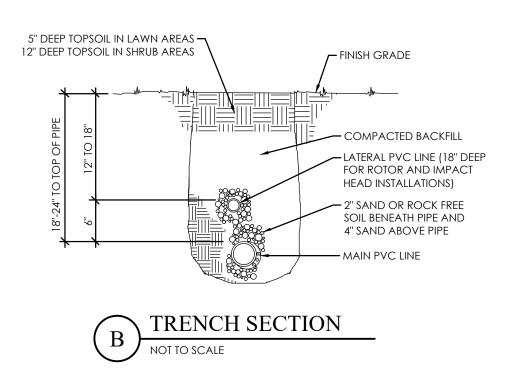

1/4" VINYL DISTRIBUTION TUBING (LENGTH=6' MAX)

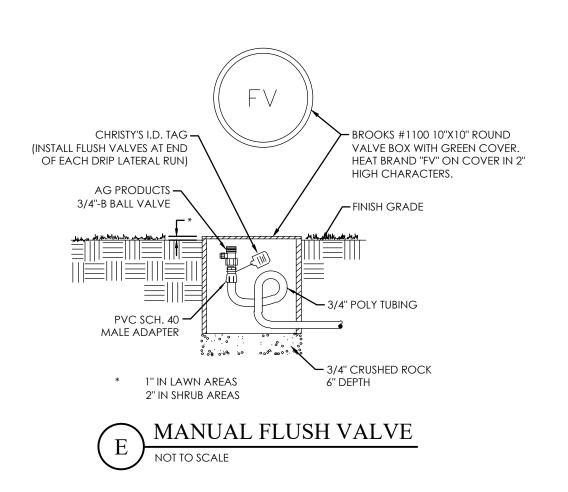


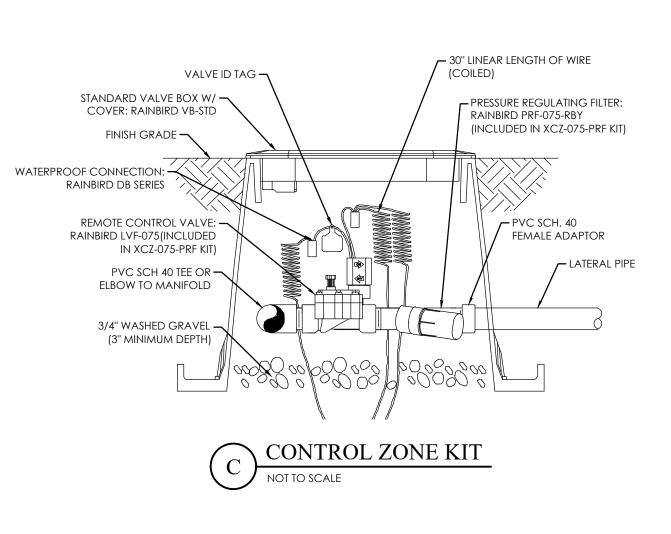


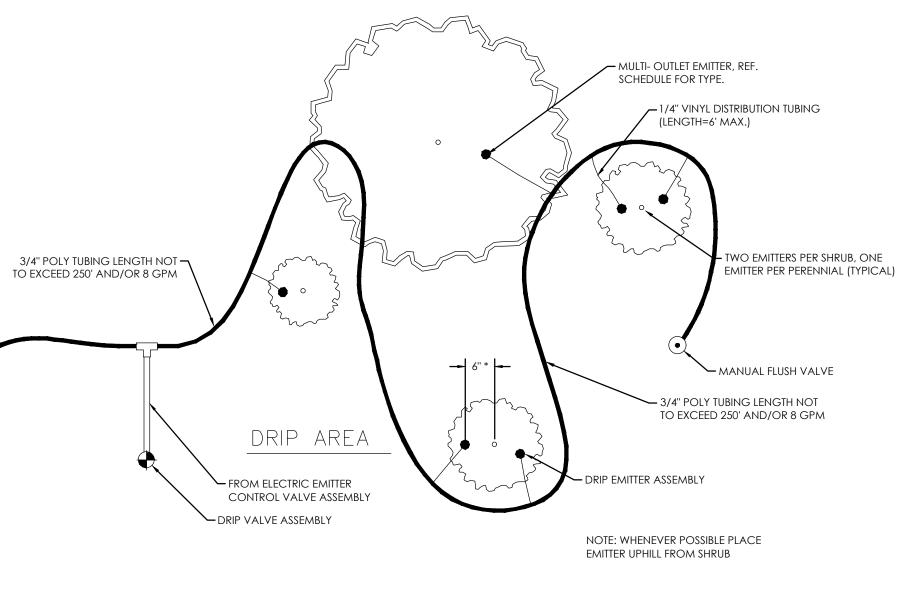

(F) TYPICAL DRIP EMITTER LAYOUT NOT TO SCALE

 \smile

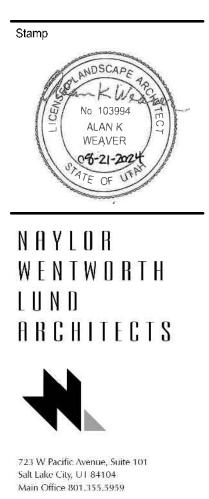

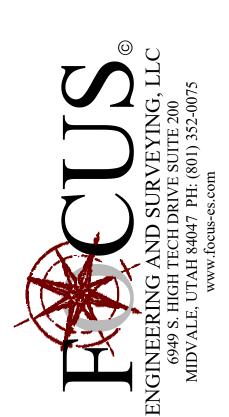



GENERAL RV CENTER 14295 Minuteman Dr. Draper, UT 84020

Addition / Renovation

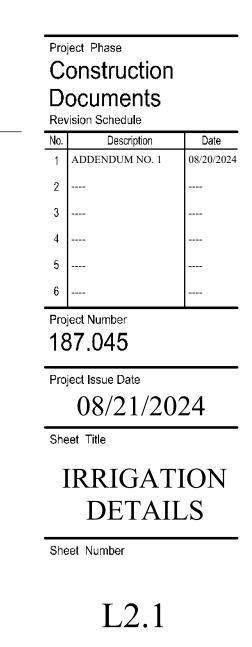


EXHIBIT H ELEVATIONS



EL - COLOR #1 COLORED / SPLIT FACED 8x8x16 CMU TO	
MATCH EXISTING PROPOSED ADDITION	TING CMU BUILDING
	t
	Ē
ESTEVATION N MATERIALS LOR 1 = 27% LOR 2 = 5% LOR COLORED / SPLIT FACED 8x8x16 CMU TO MATCH EXISTING COLORED / SMOOTH FACED 8x8x16 CMU TO MATCH EXISTING COLORED / SMOOTH FACED 8x8x16 CMU TO MATCH EXISTING SRICK - 22%	
BUILDING BUILDING SIGNAGE TO BE REFER TO ORTHOGRAPHIC REMOVED (SEE PHOTO) EXTERIOR ELELEVATION FOR SIGN SIZE SIGN SIZE	
PROPOSED AI	

ENERAL

DARK BRONZE ANODIZED METAL FRAMES TO MATCH EXISTING - TYPICAL

GENERALRY


PERSPECTIVE VIEW






Sheet Number



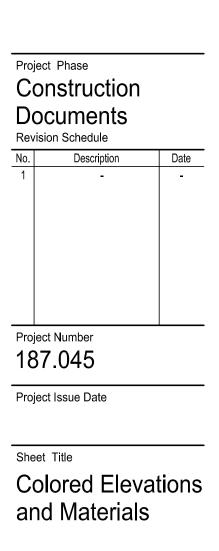

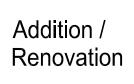

Project For GENERAL RV CENTER 14295 Minuteman Dr. Draper, UT 84020




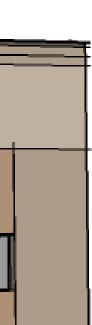






EXHIBIT I LIGHTING PLAN



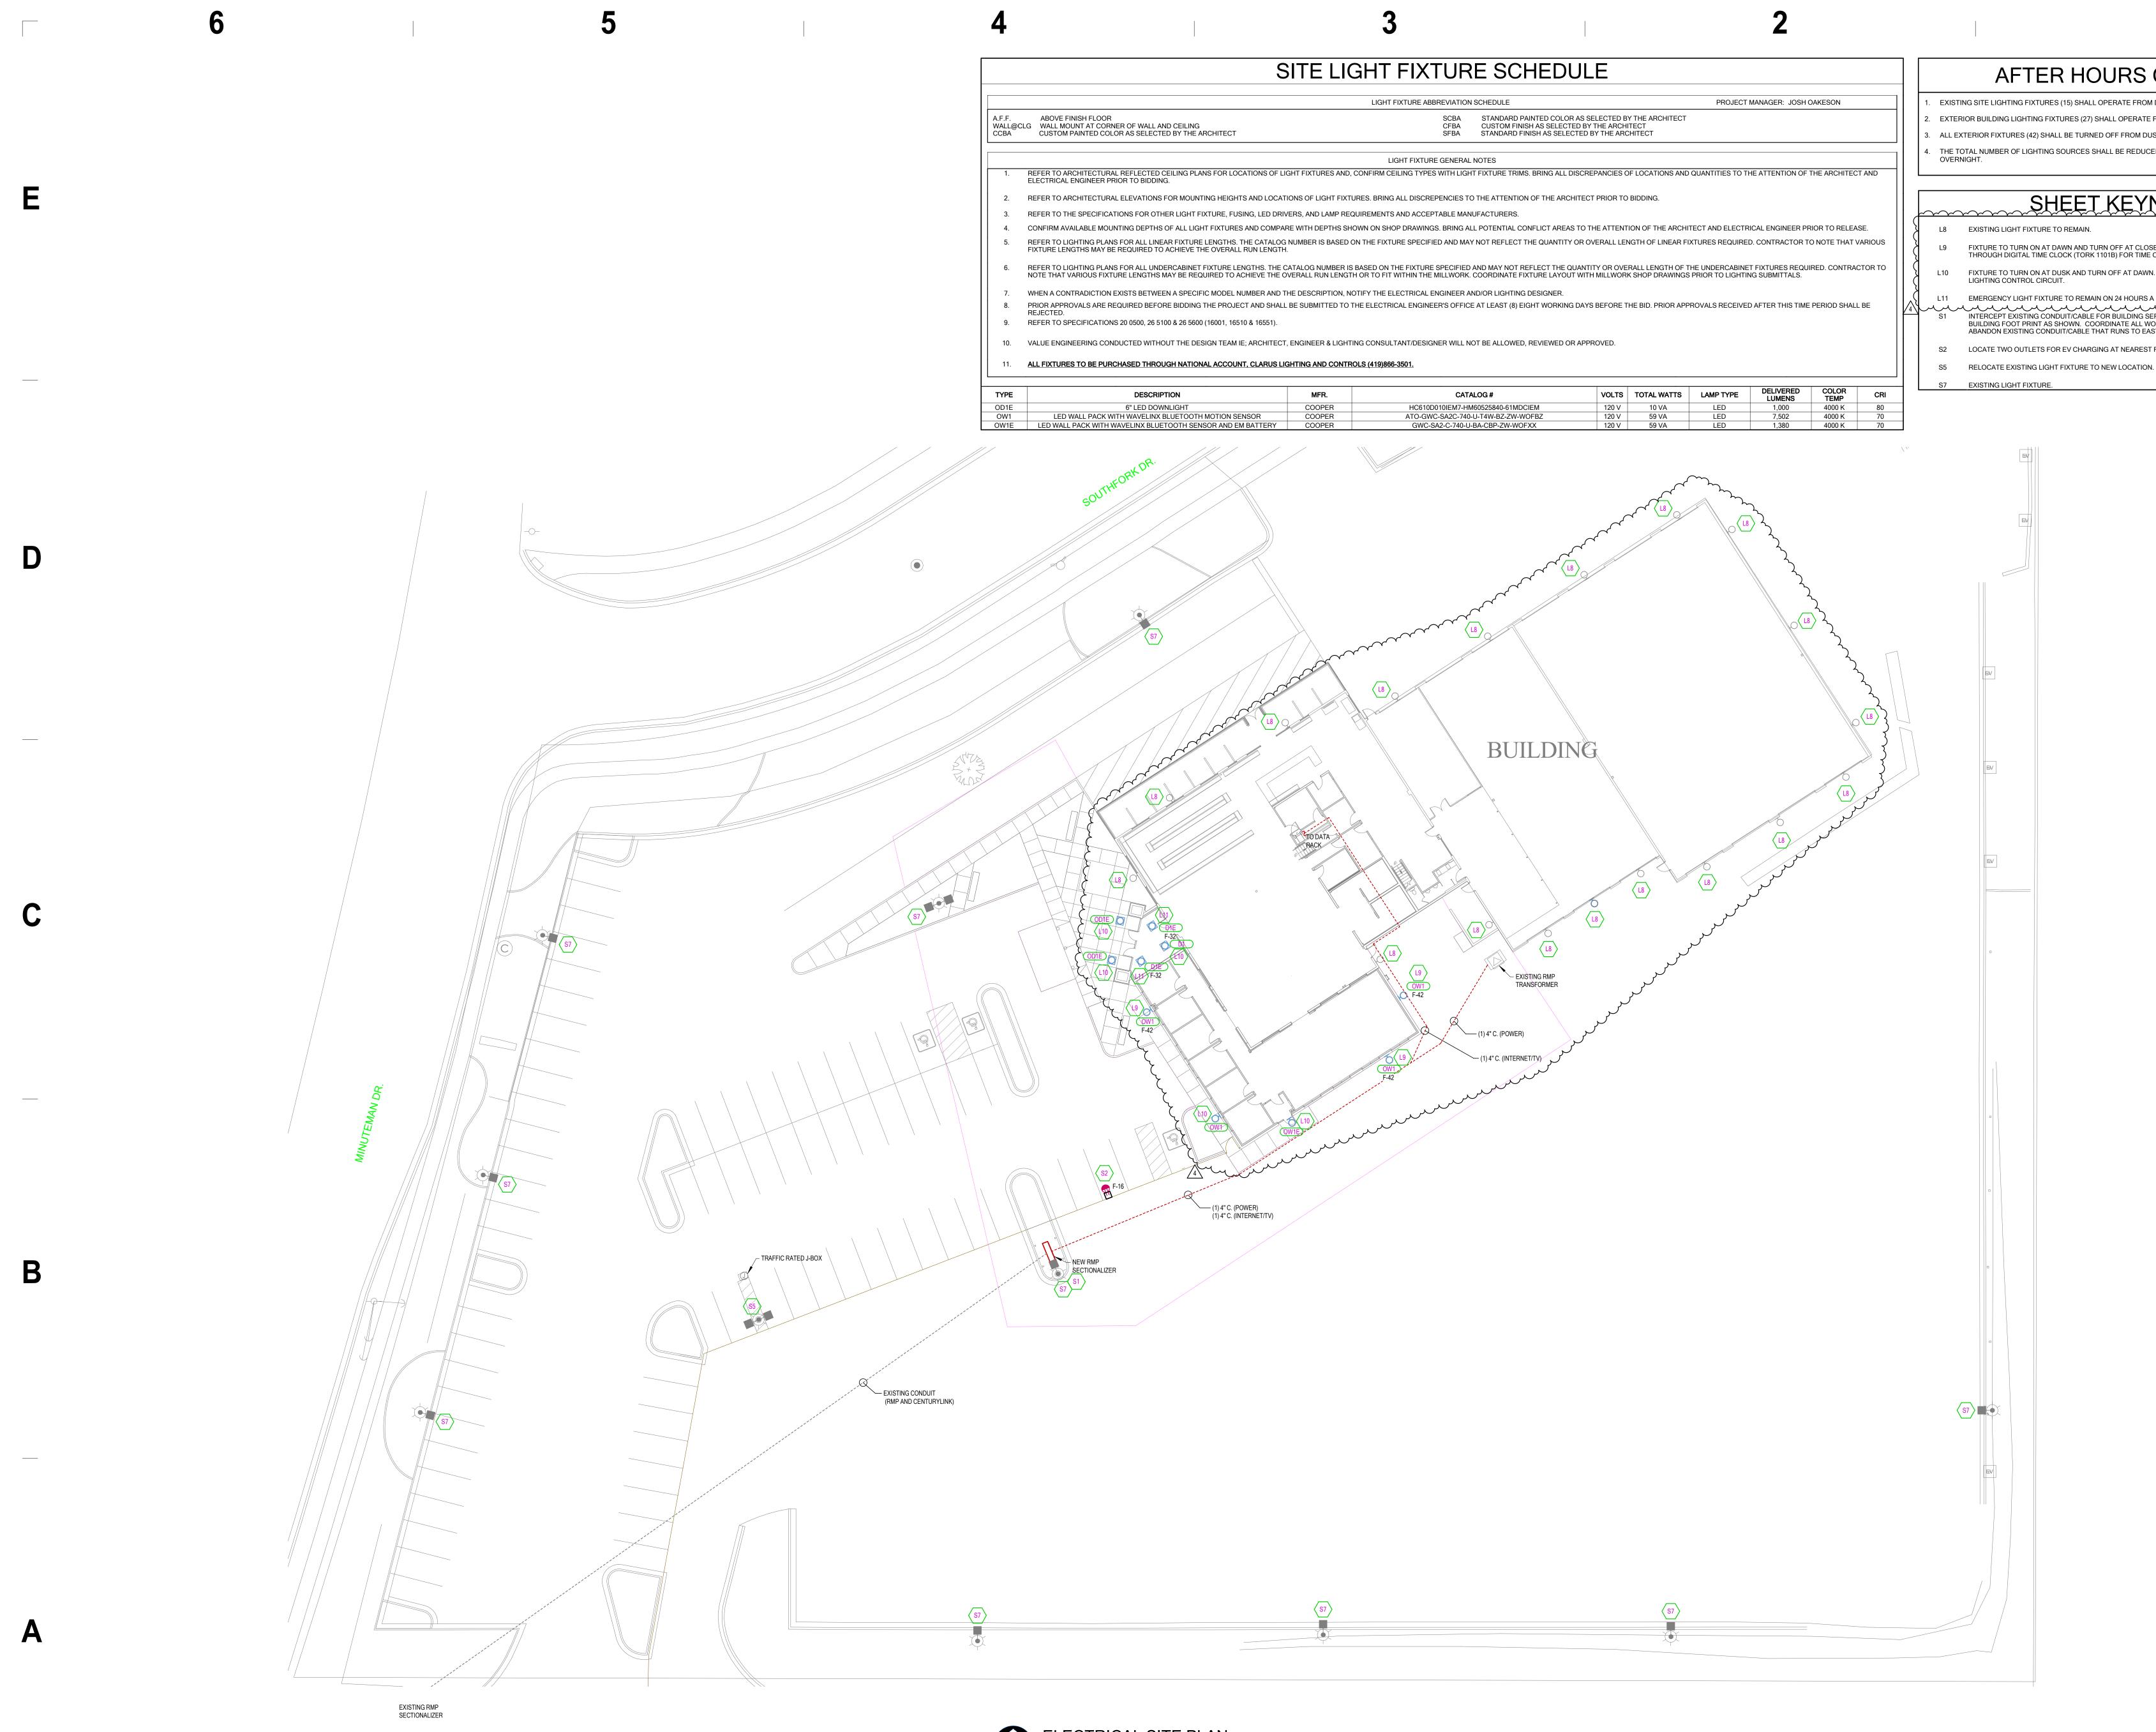

6

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3

		· · · · ·				
à#	VOLTS	TOTAL WATTS	LAMP TYPE	DELIVERED LUMENS	COLOR TEMP	CRI
25840-61MDCIEM	120 V	10 VA	LED	1,000	4000 K	80
1W-BZ-ZW-WOFBZ	120 V	59 VA	LED	7,502	4000 K	70
CBP-ZW-WOFXX	120 V	59 VA	LED	1,380	4000 K	70

2

		AFTER HOURS CONTROL		
1	. EXISTI	NG SITE LIGHTING FIXTURES (15) SHALL OPERATE FROM DUSK TO 11 P.M.		
2	. EXTEF	EXTERIOR BUILDING LIGHTING FIXTURES (27) SHALL OPERATE FROM DUSK TO DAWN.		
3	ALL EXTERIOR FIXTURES (42) SHALL BE TURNED OFF FROM DUSK TO DAWN.			
4	 THE TOTAL NUMBER OF LIGHTING SOURCES SHALL BE REDUCED BY 35% WHEN EXTERIOR FIX OVERNIGHT. 			
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	$\sim\sim$	SHEET KEYNOTES		
	L8	EXISTING LIGHT FIXTURE TO REMAIN.		
	L9	FIXTURE TO TURN ON AT DAWN AND TURN OFF AT CLOSE OF BUSINESS VIA TIME CLOCK. THROUGH DIGITAL TIME CLOCK (TORK 1101B) FOR TIME CONTROL.		
	L10	FIXTURE TO TURN ON AT DUSK AND TURN OFF AT DAWN. FIXTURE TO BE TIED TO EXISTIN LIGHTING CONTROL CIRCUIT.		
	L11	EMERGENCY LIGHT FIXTURE TO REMAIN ON 24 HOURS A DAY.		
	S1	INTERCEPT EXISTING CONDUIT/CABLE FOR BUILDING SERVICE AND EXTEND CONDUIT AF BUILDING FOOT PRINT AS SHOWN. COORDINATE ALL WORK WITH ROCKY MOUNTAIN POW ABANDON EXISTING CONDUIT/CABLE THAT RUNS TO EAST FROM THIS POINT.		
	S2	LOCATE TWO OUTLETS FOR EV CHARGING AT NEAREST FENCE POST.		

S7 EXISTING LIGHT FIXTURE.

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-	
IXTURES DEACTIVATE	
K. RUN FIXTURES	
AROUND NEW OWER AND OWNER.	





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Addition / Renovation



Project Phase CONSTRUCTION DOCUMENTS

REVISIONS			
MARK	DATE	DESCRIPTION	
2	06/12/2024	CITY COMMENTS	
3	07/17/2024	CITY SITE COMMENTS	
4	08/20/2024	Addendum No. 1	

Project Number 23405


Project Issue Date May. 07, 2024 Sheet Title



ELECTRICAL SITE PLAN

Sheet Number

ES300

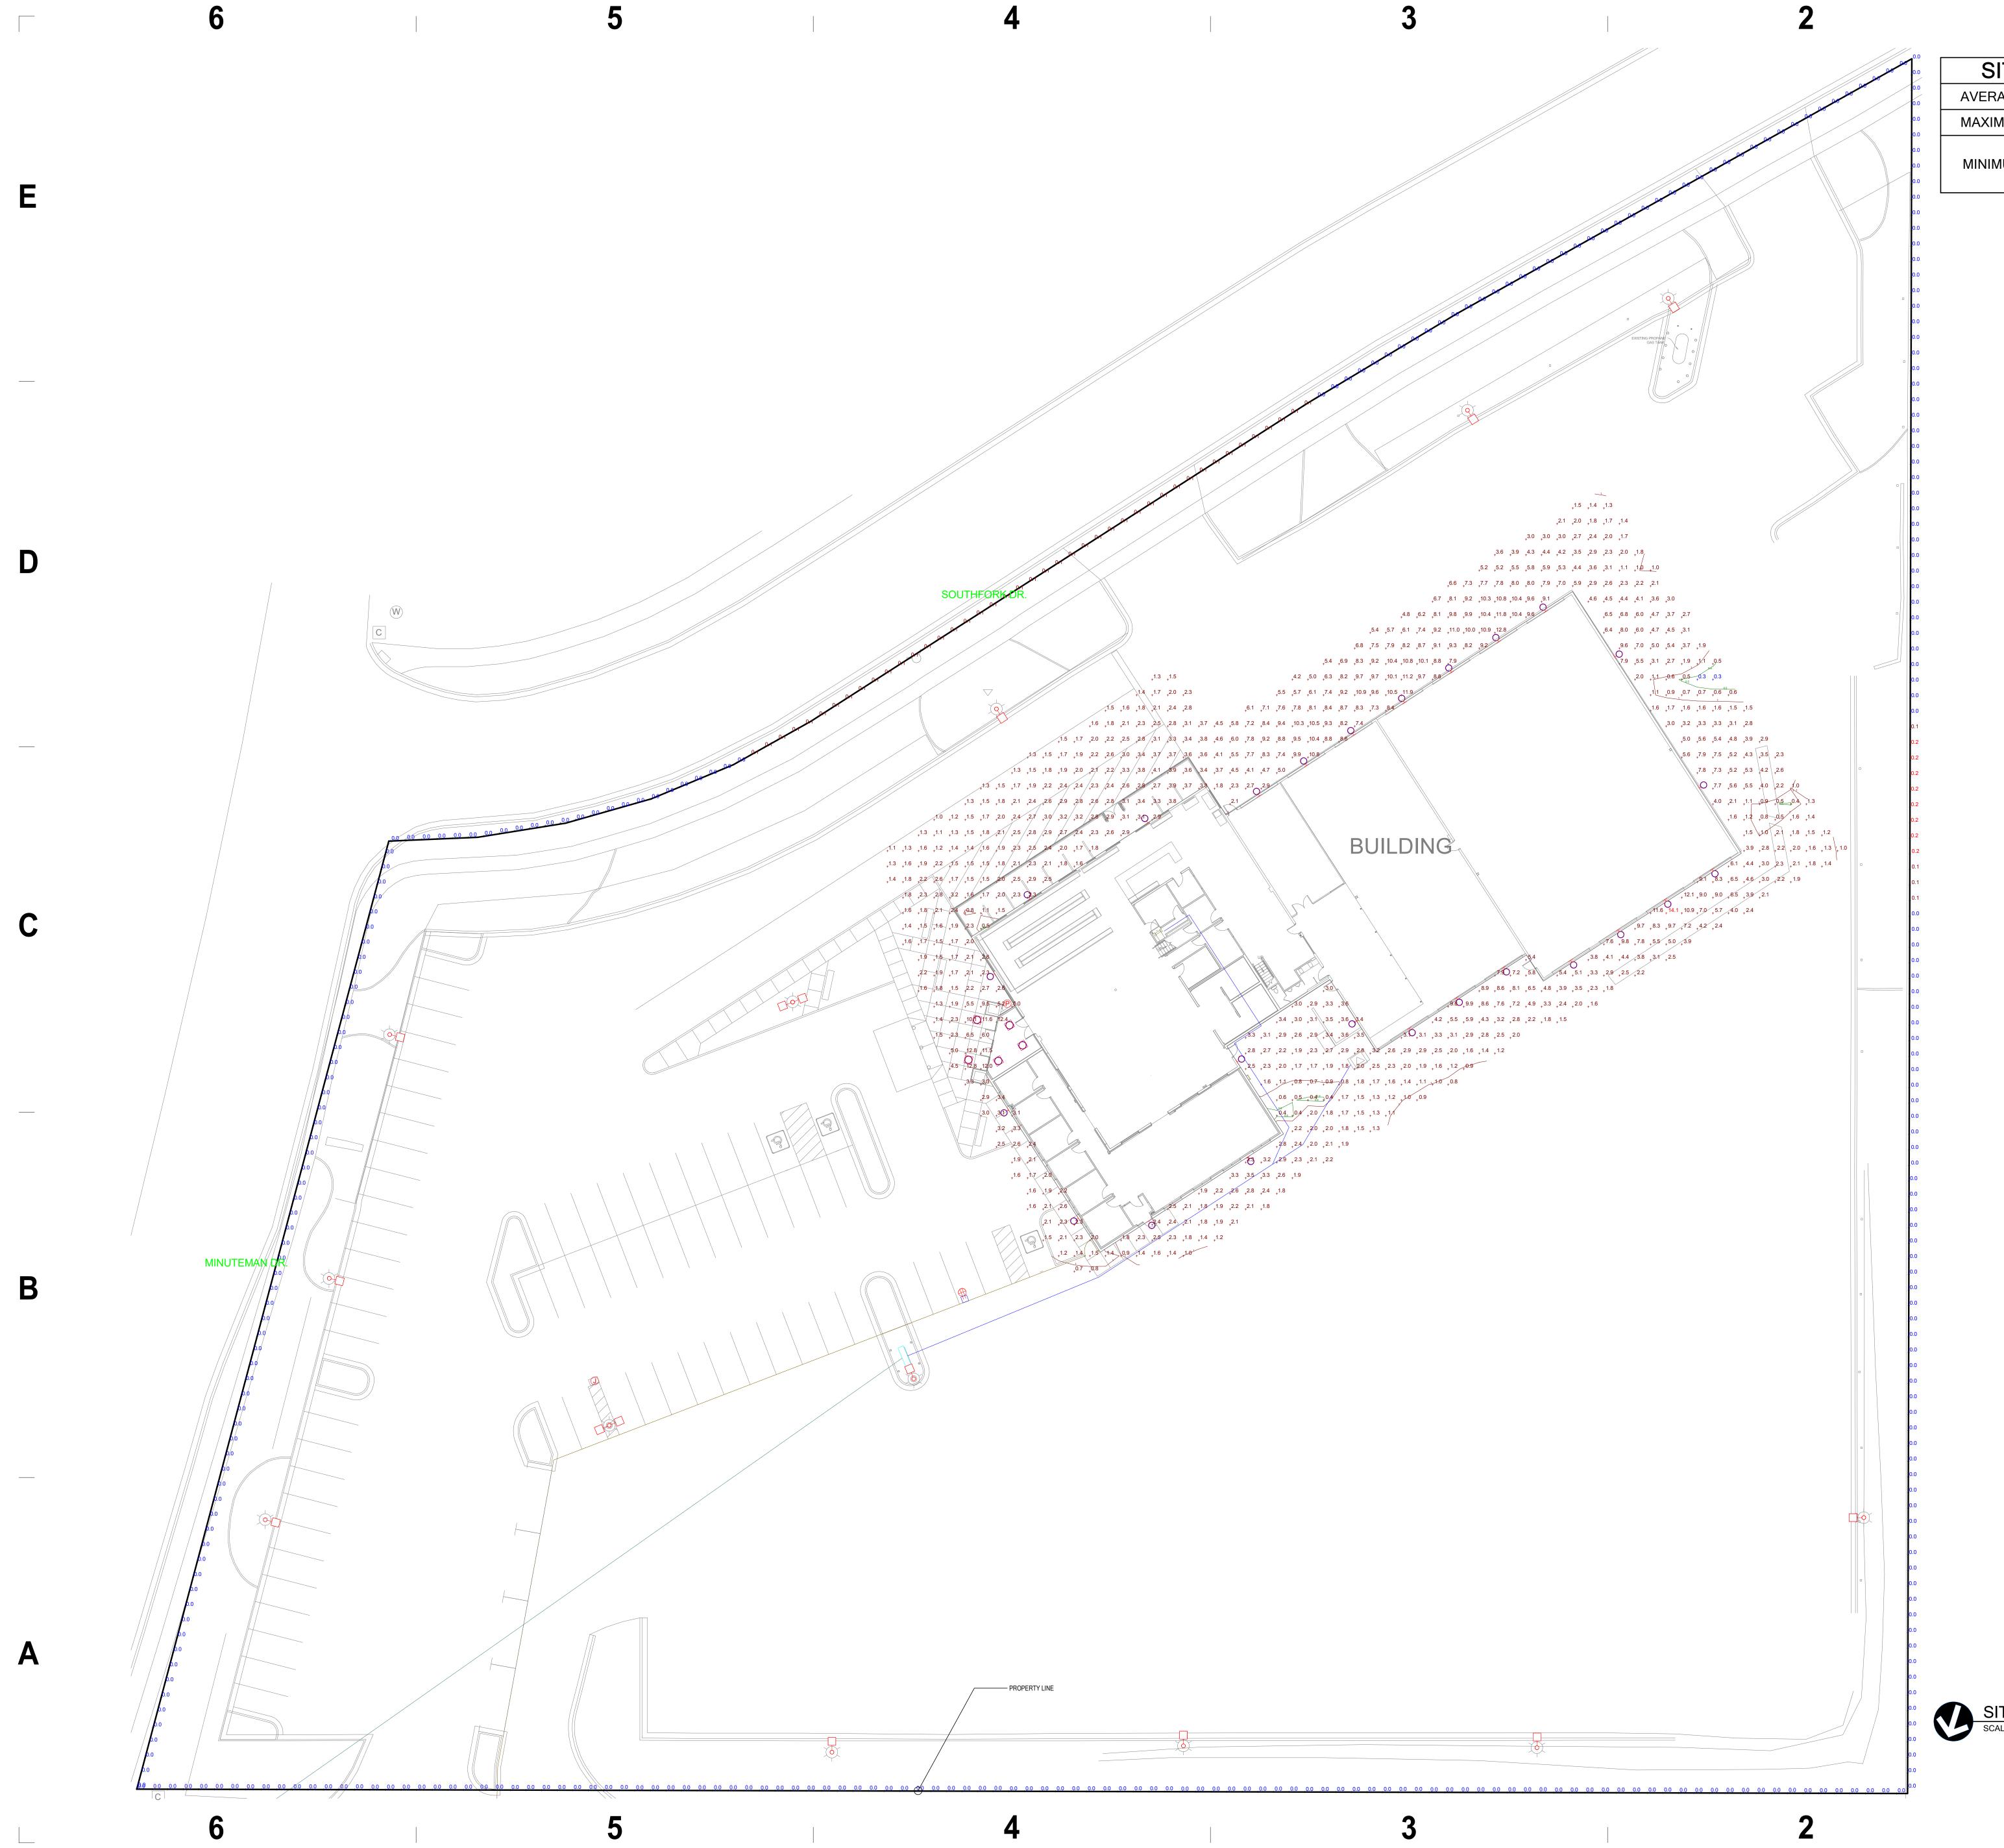

SITE CALCULATION STATISTIC AVERAGE 3.8 fc MAX/MIN MAXIMUM 14.1 fc AVG/MIN MAX ILLUMINATION RATIO MINIMUM 0.3 fc

SCALE = 1" = 20'-0"

ICS
47.0:1
12.7:1
3.71:1





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Renovation



Project Phase CONSTRUCTION DOCUMENTS

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Project Number 23405

Project Issue Date May. 07, 2024 Sheet Title SITE PHOTOMETRIC PLAN Sheet Number

ES301